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- 205 MOUNTABLE CURB
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315 TYPICAL 20" x 24" CATCH BASIN

325 DITCH INLET

330 SUBSURFACE DRAIN

331 FIGURE 3.1 - AVERAGE VELOCITY

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Drawing Number Drawing Title

335 SHALLOW TRENCH SERVICE CONNECTION, BLOCKING, & MARKING

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340 CLEANOUT DETAIL

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Drawing Number Drawing Title

345 MANHOLE ADJUSTMENT RINGS FOR RESURFACING

346 MANHOLE COVER & FRAME DETAILS

347 CAM-LOCK MANHOLE COVER AND FRAME

350 TYPICAL MANHOLE DETAIL

351 FLAT-TOP MANHOLE

352 BEAVER SLIDE MANHOLE

353 TYPICAL OUTSIDE DROP MANHOLE DETAIL

354 TYPICAL INSIDE DROP MANHOLE

355 POLLUTION CONTROL MANHOLE INSIDE ELBOW

356 POLLUTION CONTROL MANHOLE OUTSIDE ELBOW

360 MANHOLE BASE SECTION

361 LARGE MANHOLE BASE SECTION

362 LARGE CAST-IN-PLACE CONCRETE MANHOLE BASE

WATER DETAILS

Drawing Number Drawing Title

400 FIRE HYDRANT INSTALLATION

405 SINGLE WATER SERVICE INSTALLATION

406 BROOKS 12" x 20" METER BOX FOR 1" WATER METER

410 GATE VALVE SETTING DETAIL

411 18" FLANGE UP VALVE BOX AND COVER

415 AIR RELEASE VALVE


420 PERMANENT 2" BLOWOFF

421 ELIPSE # 88 SAMPLING STATION


422 TEMPORARY 2" BLOWOFF

425 COLLAR THRUST BLOCK

430 THRUST BLOCKING DETAILS

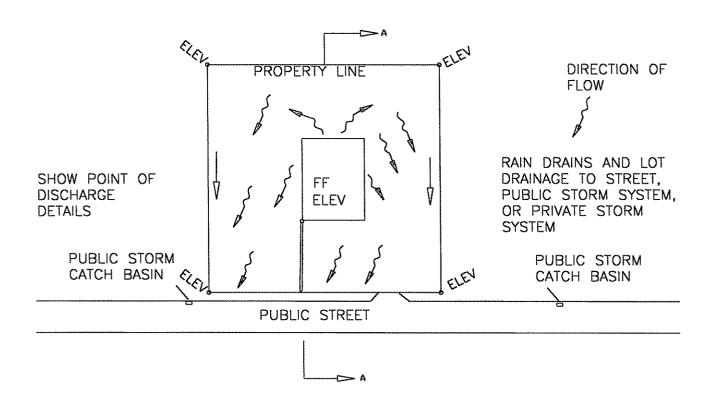


- 1. ALL DRAINAGE FROM LOT TO BE CHANNELLED TO PUBLIC OR PRIVATE STORM SYSTEM.
- 2. A SIMPLE SKETCH DRAWING SHOWING ROOF DRAINS, LOT DRAINAGE, AND A POINT OF DISCHARGE FROM PROPERTY IS REQUIRED FOR BUILDING PERMIT.
- 3. SECTIONAL VIEWS OF ALL SIDES OF LOTS SHOWING ADJACENT PROPERTIES.
- 4. PROVIDE STAMPED, ENGINEERED DRAWINGS FOR DRYWELLS. MUST BE PROVIDED BY A PROFESSIONAL ENGINEER AND INCLUDE PERC REST RESULTS.
- 5. IF DRYWELL IS USED, AN ENGINEERIED DETAIL AND PERC TESTS ARE REQUIRED.

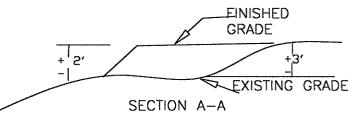

- 1. SHOW EXISTING GRADES ON ADJACENT LOTS.
- 2. SHOW FINISHED GRADE OF LOT TO BE PERMITTED.
- 3. EXISTING GRADES ON LOT TO BE PERMITTED.

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CHECKED BY:	265 THE STRAND, ST.HELENS, OR 97051 PH (503)397-6272 FAX (503)397-4016	
DATE:	TITLE: DRAWING NO:	_
SCALE:	SAMPLE DRAWING OF TYPICAL LOT DRAINAGE PLAN 199	

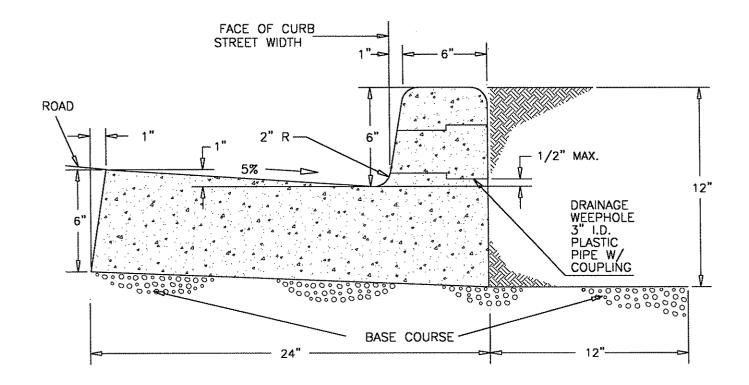


- FOR USE ALONG MEDIANS, GUTTERS MAY BE REDUCED WITH PRIOR APPROVAL FROM THE CITY ENGINEER.
- 2. CONCRETE TO HAVE A COMPRESSIVE STRENGTH OF 3300 P.S.I. AT 28 DAYS.
- CONTRACTION JOINTS

 - A. SPACING TO BE NOT MORE THAN 15 FEET.

 B. THE DEPTH OF THE JOINT SHALL BE AT LEAST 1-1/2 INCHES.

 C. WEEPHOLES TO BE CENTERED WITH CONTRACTION JOINTS.
- BASE ROCK 1 1/2"-0 OR 3/4"-0, 95% (AASHTO T-180) COMPACTION. BASE ROCK SHALL BE TO SUBGRADE OF STREET STRUCTURE OR 4 INCHES, WHICHEVER IS GREATER, AND SHALL EXTEND 12" BEHIND THE CURB.
- DRAINAGE WEEPHOLE -3" DIAMETER PLASTIC PIPE
 - A. I.D. PLASTIC PIPE WITH COUPLING.
 B. DRAINAGE ACCESS THROUGH EXISTING CURBS SHALL BE CORE DRILLED.
- 6. ALL RADII SHALL BE 3/4" EXCEPT AS OTHERWISE SHOWN.

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SCALE:	TITLE: STANDARD MONOLITHIC CURB AND GUTTER	DRAWING NO: 200

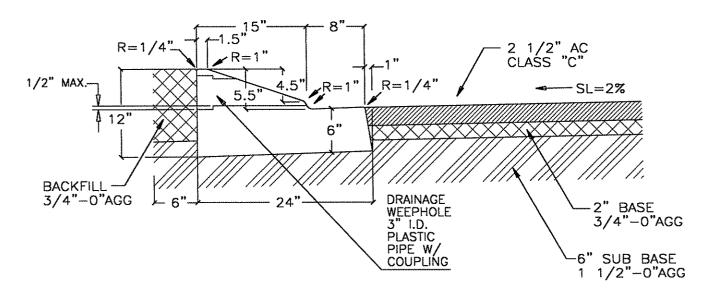

MOUNTABLE CURB

APPROVED FOR CUL-DE-SACS

MAY BE USED WITH PREAPPROVAL IN OTHER LOCATIONS STANDARD ROAD CROSS SECTION


- CONCRETE TO HAVE A COMPRESSIVE STRENGTH OF 3300 P.S.I. AT 28 DAYS.
- CONTRACTION JOINTS

- A. SPACING TO BE NOT MORE THAN 15 FEET.

 B. THE DEPTH OF THE JOINT SHALL BE AT LEAST 1-1/2 INCHES.

 C. WEEPHOLES TO BE CENTERED WITH CONTRACTION JOINTS.
- BASE ROCK 1 1/2"-0 OR 3/4"-0, 95% (AASHTO T-180) COMPACTION. BASE ROCK SHALL BE TO SUBGRADE OF STREET STRUCTURE OR 4 INCHES, WHICHEVER IS GREATER, AND SHALL EXTEND 12" BEHIND THE CURB.
- DRAINAGE WEEPHOLE -3" DIAMETER PLASTIC PIPE A. I.D. PLASTIC PIPE WITH COUPLING.
 - B. DRAINAGE ACCESS THROUGH EXISTING CURBS SHALL BE CORE DRILLED.
- 5. WHEN USING MOUNTABLE CURB 6" S/W SHALL BE USED.

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SCALE:	TITLE:	MOUNTABLE CURB	DRAWING NO:

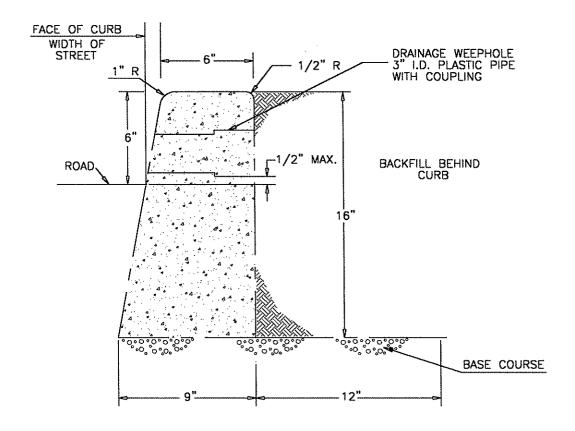

- 1. THIS DETAIL TO BE USED ONLY WHEN REPLACING LIKE CURB. NOT INTENDED FOR NEW CONSTRUCTION UNLESS SPECIFICALLY APPROVED BY THE CITY ENGINEER.
- CONCRETE TO HAVE COMPRESSIVE STRENGTH OF 3300 P.S.I. AFTER 28 DAYS.

EXPANSION JOINTS.


- A. TO BE PROVIDED:
 - 1) AT EACH POINT OF TANGENCY OF THE CURB.
 2) AT EACH COLD JOINT.
 3) AT EACH SIDE OF INLET STRUCTURES.
 4) AT EACH END OF DRIVEWAYS.
- B. MATERIAL TO BE PRE-MOLDED, ASPHALT IMPREGNATED, NON-EXTRUDING, WITH A THICKNESS OF 1/2 INCH.
- 3. CONTRACTION JOINTS.

 - A. SPACING TO BE NOT MORE THAN 15 FEET.


 B. THE DEPTH OF THE JOINT SHALL BE AT LEAST 1-1/2 INCHES.

 C. WEEPHOLE TO BE CENTERED WITH CONTRACTION JOINTS.
- BASE ROCK 1 1/2"-0 OR 3/4"-0, 95% (AASHTO T-180) COMPACTION. BASE ROCK SHALL BE TO SUBGRADE OF STREET STRUCTURE OR 4" IN DEPTH, WHICHEVER IS GREATER. SUBGRADE ROCK TO EXTEND 12" BEHIND CURB.
- 5. DRAINAGE WEEPHOLE 3" DIA, PLASTIC PIPE.
 A. I.D. PLASTIC PIPE WITH COUPLING.
 B. DRAINAGE ACCESS THROUGH EXISTING CURBS SHALL BE CORE DRILLED.


DRAWN BY: T. KOLLN CHECKED BY: . DATE:	CITY OF ST. HIELENS 265 THE STRAND, ST. HELENS, OR 97051 PH (503)397-6272 FAX (503)397-4016	REVISION:
SCALE:	TITLE: TYPE 'A' CURB — (ON SPECIAL APPLICATION)	DRAWING NO:

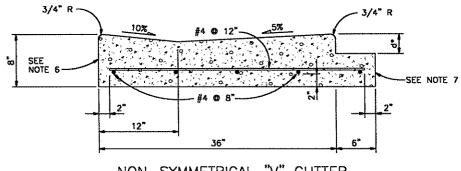

NON-SYMMETRICAL "V" GUTTER

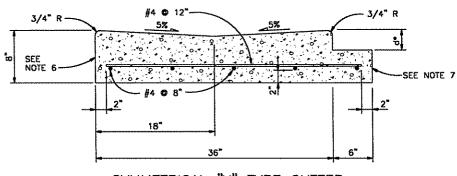


SYMMETRICAL "V" TYPE GUTTER

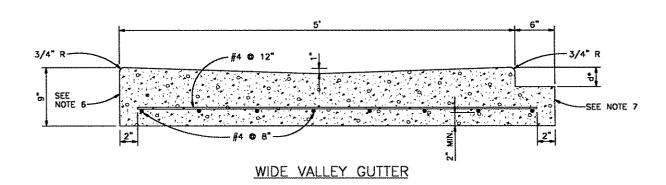


- 1. d* = THICKNESS OF ASPHALT PAVING.
- 2. THE CONCRETE SHALL BE CLASS 3300.
- 3. THE TOTAL WIDTH OF THE NON-SYMMETRICAL "V" GUTTER MAY BE REDUCED TO 30" WHEN CONSTRUCTION WITH A CURB-EXTRUSION MACHINE.
- 4. CONSTRUCT 6" BENCH MONOLITHICALLY WITH VALLEY GUTTER TO EXTEND UNDER PAVING FOR PAVEMENT SUPPORT.
- 5. WHEN BENCH IS NOT REQUIRED, CONSTRUCT 1" BATTER ON VERTICAL FACE.
- 6. PLACE PREMOLDED FILLER AGAINST VERTICAL FACE WHERE VALLEY GUTTER ABUTS CONCRETE.
- 7. CONSTRUCT 6" x d DEPRESSED BENCH WHERE VALLEY GUTTER ABUTS ASPHALT PAVEMENT.

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SCALE:	TITLE:	CONCRETE VALLEY GUTTER	DRAWING NO: 215

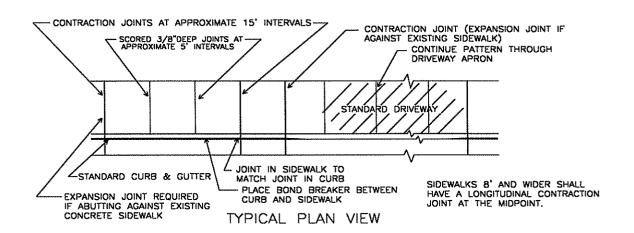


- STANDARD SIDEWALK CROSS SLOPE SHALL BE 1/4"/FOOT. WHEN THE LOT IS BELOW THE TOP OF THE CURB AND SLOPES DOWN FROM THE CURB A MINUS 1/4"/FOOT SLOPE MAY BE REQUIRED.
- CONCRETE DEPTH FOR STANDARD SIDEWALKS SHALL BE NOMINAL 4" MIN. DRIVEWAY SECTIONS INCLUDING SIDEWALKS THROUGH DRIVEWAYS SHALL BE NOMINAL
- EXPANSION JOINTS WITH PREMOLDED FILLER SHALL BE INSTALLED BETWEEN DRIVEWAYS AND SIDEWALK AT THE DIRECTION OF THE ENGINEER. (SEE DRIVE-WAY DETAILS) CONTRACTION JOINTS SHALL BE INSTALLED AT APPROXIMATE INTERVALS OF 15 FEET BY CUTTING AT LEAST 1/3 OF THE DEPTH OF THE CONCRETE. "DUMMY" JOINTS SHALL BE INSTALLED AT APPROXIMATE INTERVALS OF 5 FEET.
- INSTALL A BOND BREAKER OR ISOLATION JOINT BETWEEN BACK OF CURB AND SIDEWALK, AND AROUND ANY OBSTRUCTION WITHIN SIDEWALK AREA. 4)
- SEE STANDARD WHEEL CHAIR/BICYCLE RAMP DETAILS FOR SIDEWALK PATTERNS AT INTERSECTION CURB RETURNS
- SEE, ALSO, STANDARD DETAILS FOR DRIVEWAYS. NO. 242 6)
- WHEN USED IN CONJUNCTION WITH MOUNTABLE CURB IN CUL-DE-SAC'S LESS THAN 45' IN RADIUS, 6" THICK SIDEWALK IS REQ'D 7)
- 8) SIDE WALK WIDTHS SHALL BE: 6-FT MINIMUM ON COLLECTOR STREETS; 5-FT MINIMUM ON RESIDENTIAL

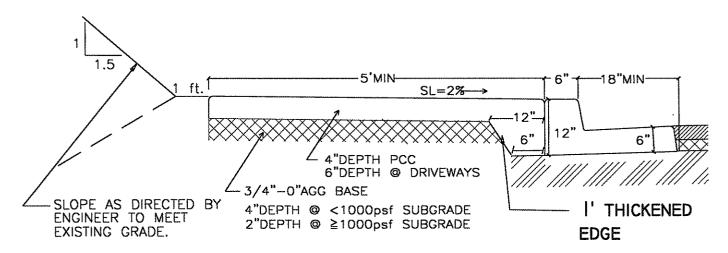

- 1. CONCRETE TO HAVE A BREAKING STRENGTH OF 3300 PSI AFTER 28 DAYS.
- 2. PCC CONTRACTION JOINTS


 - A. SPACING TO BE 15 FEET OR LESS.
 B. DEPTH TO BE AT LEAST 1 1/2".
 C. TO BE CENTERED OVER ANY WEEPHOLES.
- 3. PCC EXPANSION JOINTS
 - A. TO BE PROVIDED:
 - 1. AT EACH POINT OF TANGENCY OF THE CURB.
 - 2. AT EACH COLD JOINT.
 - 3. AT EACH SIDE OF INLET STRUCTURES.
 - 4. AT EACH END OF DRIVEWAYS.
 - B. MATERIAL TO BE PRE-MOLDED, ASPHALT IMPREGNATED, NONEXTRUDING, 1/2" THICK.
- 4. SEE DETAIL FOR CURB & GUTTER

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DATE:	TITLE:	· · · · · · · · · · · · · · · · · · ·	DRAWING NO:
SCALE:		SIDEWALK DETAILS	220

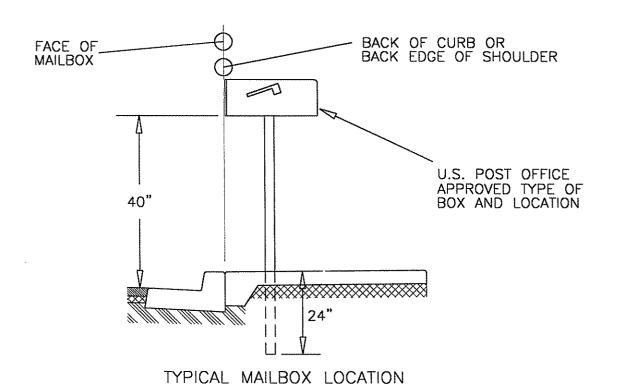




- 1. THE CITY OF ST. HELENS
 HAS ADOPTED THE M.U.T.C.D.
 BY ORDINANCE
- 2. ONLY STREET NAME SIGNS MAY BE MOUNTED ON STOP SIGN POSTS
- 3. INSTALLATION BY CITY OF ST. HELENS, COORDINATED BY CONTRACTOR

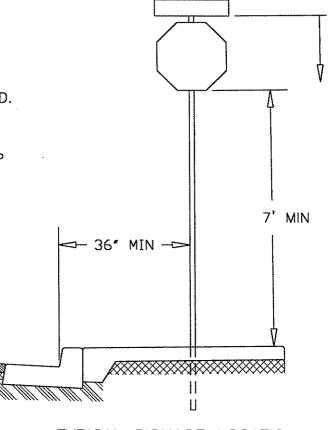


9' MIN FOR

STREET NAME SIGNS MOUNTED ALONE


TYPICAL SIGNAGE LOCATION

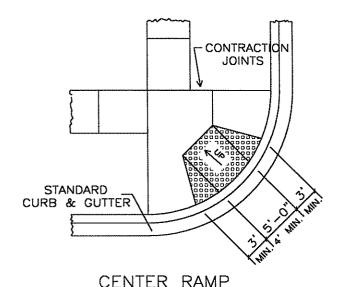


EXTG PROPERTY LINE SIDEWALKS

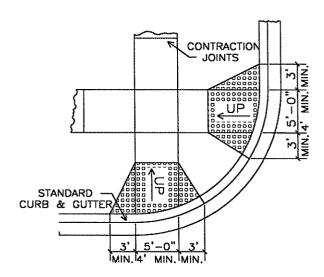

END RAMPS
EXTG PROPERTY LINE SIDEWALKS

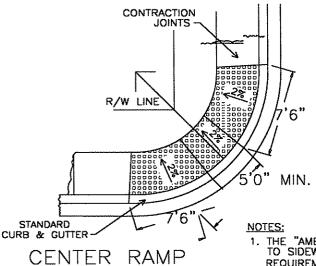


FOR CURB LINE SIDEWALKS

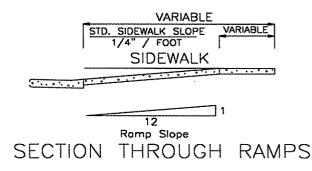

 THE "AMERICANS WITH DISABILITIES ACT" (ADA) REQUIRES THAT ACCESS RAMPS TO SIDEWALKS CONFORM TO ALL FEDERAL GUIDELINES. EXCEPTIONS TO THE REQUIREMENTS IN THIS DRAWING MUST BE APPROVED BY THE ENGINEER AND MUST COMPLY WITH ADA.

- 2. NO ABOVE GROUND UTILITIES ARE PERMITTED WITHIN RAMP AREA.
- 3. LANDINGS SHALL BE PLACED AT THE TOP OF EACH RAMP.
 LANDING SLOPES SHALL NOT EXCEED 50:1 IN ANY DIRECTION.
 THE SLOPE OF THE SURFACING AT THE BOTTOM OF THE RAMP
 SHALL NOT EXCEED 20:1 FOR A DISTANCE OF 2' (SEE TYPICAL SECTION ABOVE).
- 4. MINIMUM LANDING DIMENSIONS SHALL BE 4'x 4'.
- 5. RAMP SURFACE SHALL BE TEXTURED WITH RAISED DIAMOND TEXTURE. TEXTURING SHALL BE DONE WITH AN EXPANDED METAL GRATE STAMPED INTO THE CONCRETE.
- 6. CONCRETE STRENGTH SHALL BE 3300 PSI.


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SCALE:	TITLE: RESIDENTIAL STI	REET WHEELCHAIR & BICYCLE RAMPS	DRAWING NO:

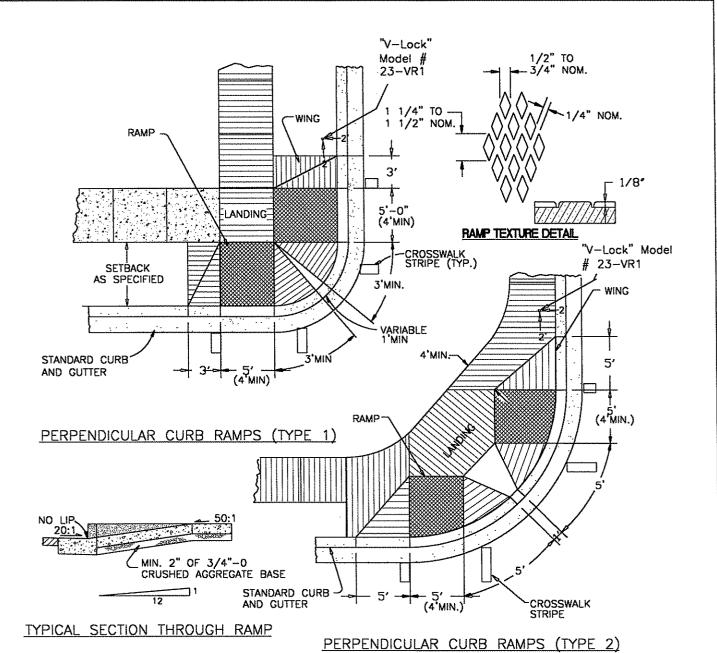

- 1. THE "AMERICANS WITH DISABILITIES ACT" (ADA) REQUIRES THAT ACCESS RAMPS TO SIDEWALKS CONFORM TO ALL FEDERAL GUIDELINES. EXCEPTIONS TO THE REQUIREMENTS IN THIS DRAWING MUST BE APPROVED BY THE ENGINEER AND MUST COMPLY WITH ADA.
- 2. NO ABOVE GROUND UTILITIES ARE PERMITTED WITHIN RAMP AREA.
- 3. LANDINGS SHALL BE PLACED AT THE TOP OF EACH RAMP. LANDING SLOPES SHALL NOT EXCEED 50:1 IN ANY DIRECTION. THE SLOPE OF THE SURFACING AT THE BOTTOM OF THE RAMP SHALL NOT EXCEED 20:1 FOR A DISTANCE OF 2' (SEE TYPICAL SECTION ABOVE).
- 4. MINIMUM LANDING DIMENSIONS SHALL BE 4' X 4'.


- 5. RAMP SURFACE SHALL BE TEXTURED WITH RAISED DIAMOND TEXTURE. TEXTURING SHALL BE DONE WITH AN EXPANDED METAL GRATE STAMPED INTO THE CONCRETE.
- 6. CONCRETE STRENGTH SHALL BE 3300 PSI.
- INSTALL V-LOCK (MODEL #23-VR1 OR EQUAL) 2-FT FROM FACE OF CURB AND 2-FT BACK FROM CONTRACTION JOINT.
- 8. V-LOCK TO BE SET PLUMB AND TO BE FLUSH WITH FINISH GRADE. CITY TO INSPECT PRIOR TO CONCRETE PLACEMENT.


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DATE:	TITLE		DOMESTIC AND
SCALE:	TITLE:	ARTERIAL / COLLECTOR STREET WHEELCHAIR ACCESS RAMPS	DRAWING NO: 230

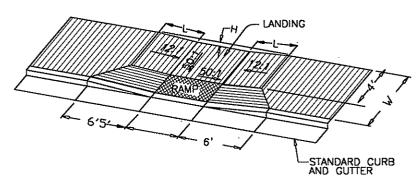

W	L	Н
5'	4.36	7/16"
5.5'	4.05	13/32"
6'	3.73	3/8"
6.5'	3.41	11/32"
7'	3.10	5/16"
7.51	2.78	9/32"
8'	2.46	1/4"
8.5	2.15	7/32"
9'	1.83	3/16"
9.5'	1.51	5/32"
10'	1.20'	1/8"
10.5	0.78	3/32"

COMBINED CURB RAMP

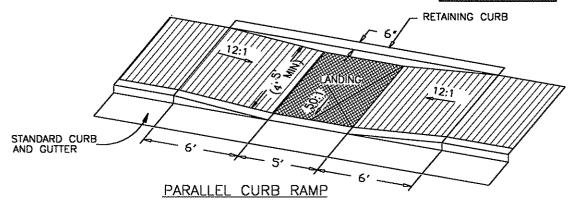


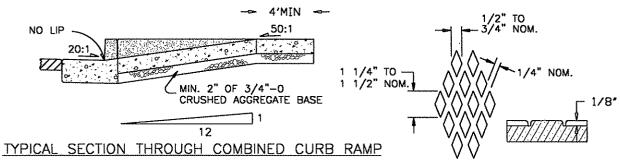


RAMP TEXTURE DETAIL

- 1. THE "AMERICANS WITH DISABILITIES ACT" (ADA) REQUIRES THAT ACCESS RAMPS TO SIDEWALKS CONFORM TO ALL FEDERAL GUIDELINES. EXCEPTIONS TO THE REQUIREMENTS IN THIS DRAWING MUST BE APPROVED BY THE ENGINEER AND MUST COMPLY WITH ADA.
- 2. NO ABOVE GROUND UTILITIES ARE PERMITTED WITHIN RAMP AREA.
- 3. LANDINGS SHALL BE PLACED AT THE TOP OF EACH RAMP. LANDING SLOPES SHALL NOT EXCEED 50:1 IN ANY DIRECTION. THE SLOPE OF THE SURFACING AT THE BOTTOM OF THE RAMP SHALL NOT EXCEED 20:1 FOR A DISTANCE OF 2' (SEE TYPICAL SECTION ABOVE).
- 4. MINIMUM LANDING DIMENSIONS SHALL BE 4'x 4'.
- 5. RAMP SURFACE SHALL BE TEXTURED WITH RAISED DIAMOND TEXTURE. TEXTURING SHALL BE DONE WITH AN EXPANDED METAL GRATE STAMPED INTO THE CONCRETE.
- 6. CONCRETE STRENGTH SHALL BE 3300 PSI.

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SCALE:	TITLE:	WHEELCHAIR ACCESS RAMP	drawing no: 235

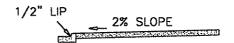


SECTION A-A

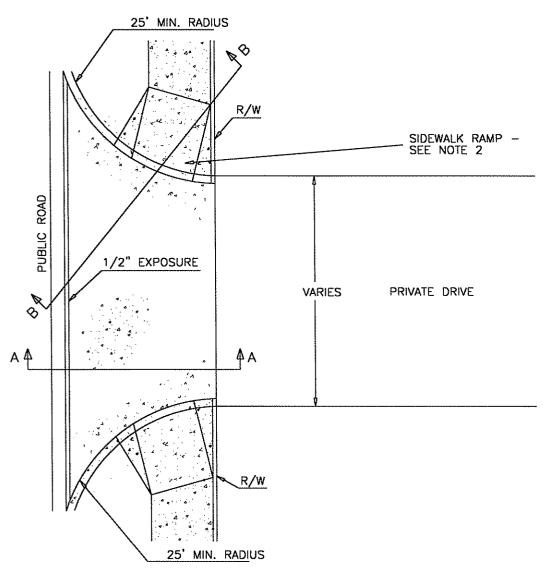

NOTES:


1. THIS DETAIL TO BE USED ONLY WHEN DIRECTED BY CITY ENGINEER.


DRAWN BY: T. KOLLN	CITY OF ST. HELENS	REVISION:
CHECKED BY:	265 THE STRAND, ST.HELENS, OR 97051 PH (503)397-6272 FAX (503)397-4016	NC
DATE:		
•	[Filhabar	DRAWING NO:
SCALE:	COMMERICAL DRIVEWAY WITH CURBS	245

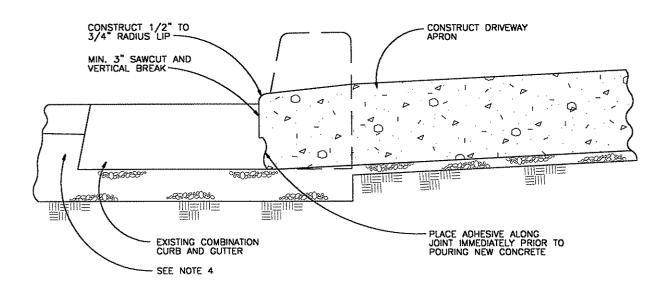


- 1. SAWCUT THROUGH GUTTER PLATE SHALL BE MADE AS CLOSE TO CURB FACE AS POSSIBLE.
- 2. COMPLETE CURB AND GUTTER SHALL NOT BE REMOVED UNLESS DIRECTED BY THE ENGINEER.
- 3. WHEN STRAIGHT CURBS ARE REMOVED, A MINIMUM OF 2 FEET OF PAVEMENT FROM THE FACE OF CURB SHOULD BE REMOVED AND REPLACED.
- 4. WHEN ENTIRE GUTTER PLATE IS REMOVED THE EXISTING PAVEMENT SHALL BE CUT BACK AND A 6" MONOLITHIC CONCRETE BENCH SHALL BE CONSTRUCTED WITH THE NEW GUTTER TO PROVIDE SUPPORT UNDER PAVEMENT. (SEE CONCRETE VALLEY GUTTER DETAIL).


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CHECKED BY:		265 THE STRAND, ST.HELENS, OR 97051 PH (503)397-6272 FAX (503)397-4016	NC
DATE:	TITLE:		DRAWING NO:
SCALE:		CURB KNOCKOUT FOR DRIVEWAYS	250

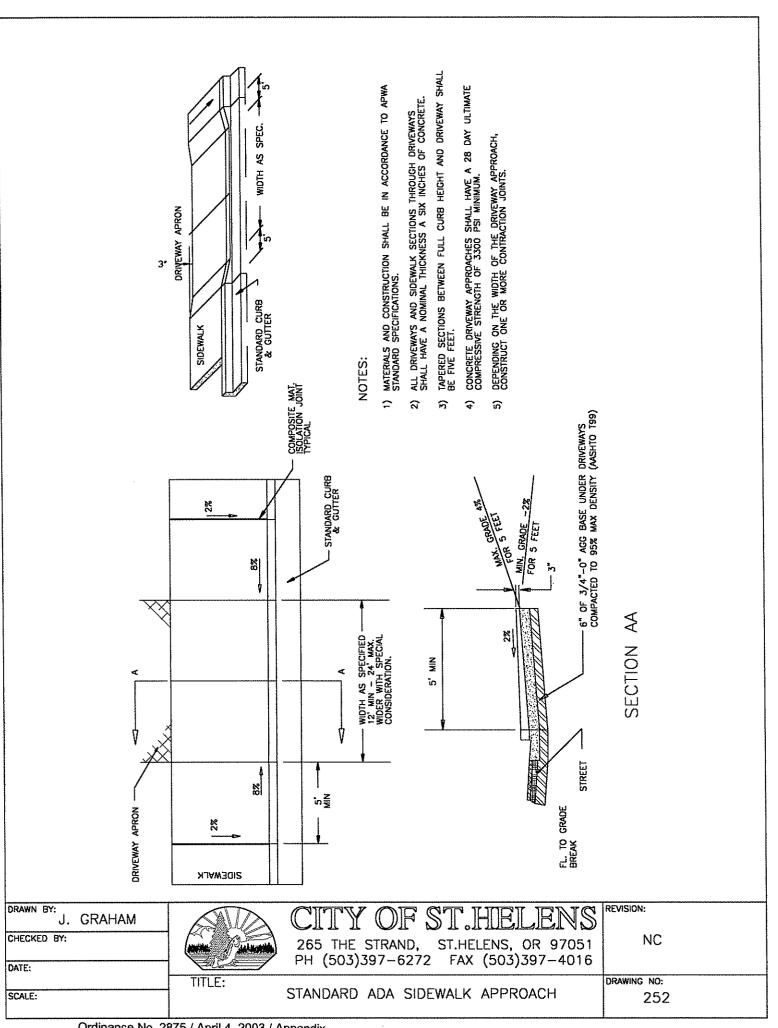

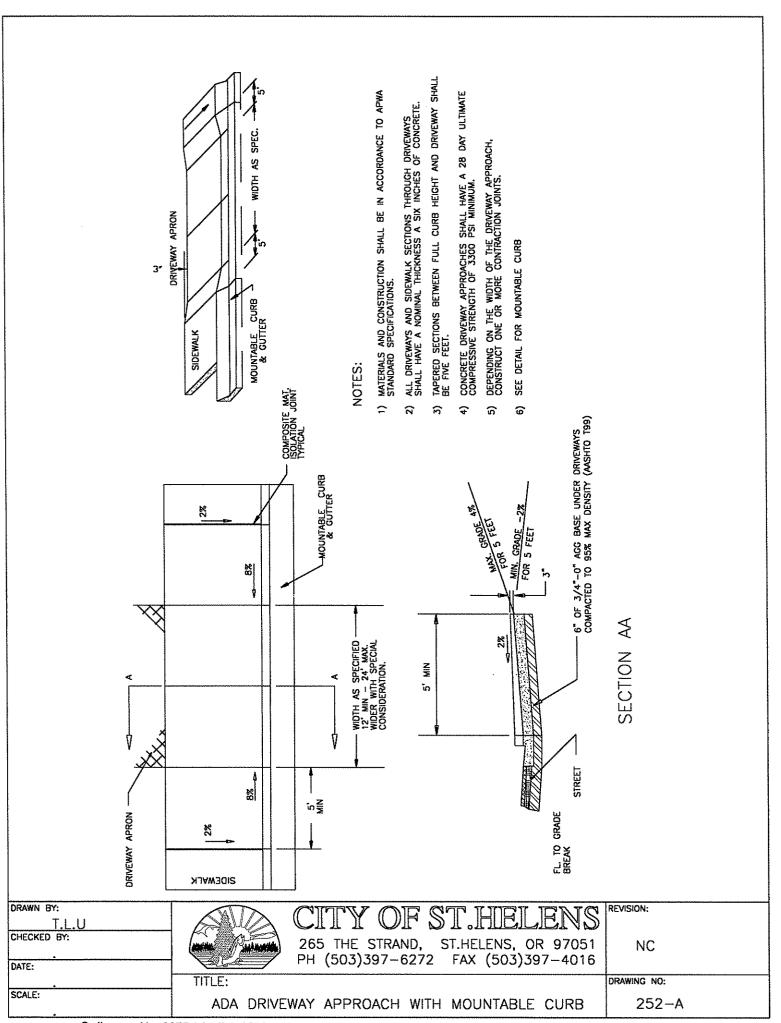


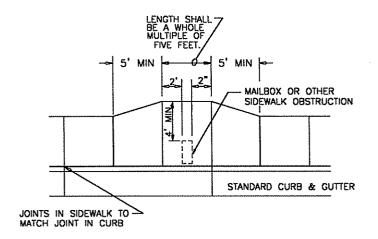

REQUIRED SIDEWALK WIDENING AROUND OBSTRUCTIONS

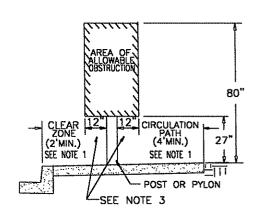


POST MOUNTED OBSTRUCTION
WITHIN SIDEWALK

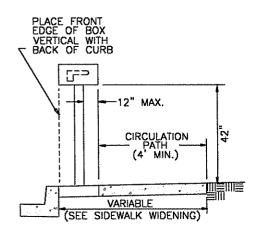

TYPICAL MAILBOX INSTALLATION

NOTES:

- CLEAR ZONE AND THE CIRCULATION PATH MAY BE COMBINED PROVIDING A 5 FOOT MINIMUM SIDEWALK WIDTH IS MAINTAINED.
- 2) DEFLECT SIDEWALK AROUND AREA OF OBSTRUCTION WHEN OVERHANGS EXCEED ALLOWABLE LIMITS.
- WHEN OBSTRUCTIONS ARE LOCATED WITHIN THE SIDEWALK AREA THE DIMENSION APPLIES IN ALL DIRECTIONS.
- INSTALL FULL DEPTH EXPANSION JOINT AROUND ALL OBSTRUCTIONS PENETRATING SIDEWALK SURFACE.
- 5) ON CUL-DE-SACS, PLACE FRONT EDGE OF MAILBOX 6 INCHES BEHIND BACK OF CURB.
- 6) EXCEPTIONS TO THE REQUIREMENTS IN THIS DRAWING MUST BE APPROVED BY THE ENGINEER AND MUST COMPLY WITH 'AMERICANS WITH DISABILITY ACT.'

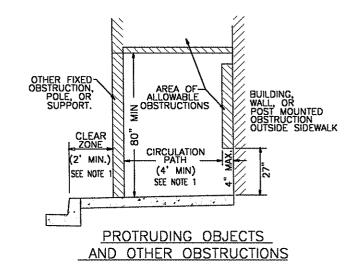

CHECKED BY:

DATE:

TITLE:


SCALE:

CHECKED BY:

CHECKED BY:

265 THE STRAND, ST.HELENS, OR 97051
PH (503)397-6272 FAX (503)397-4016


DRAWING NO:
255

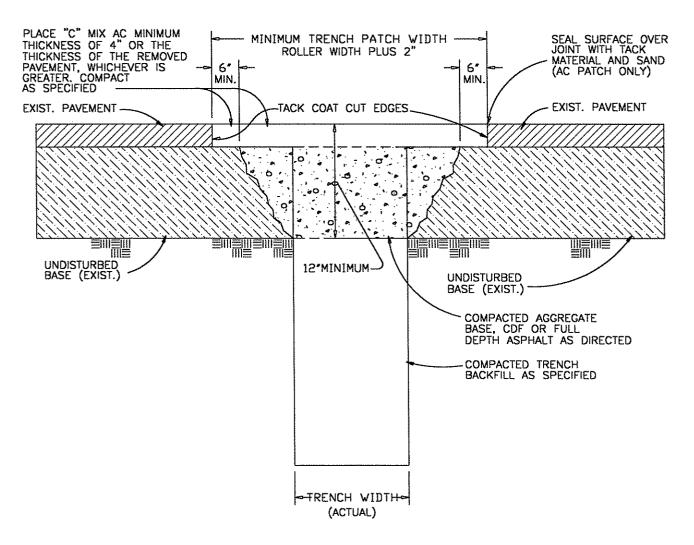

- ALL EXISTING AC OR PCC PAVE— MENT SHALL BE SAWCUT PRIOR TO REPAVING.
- 2. CONCRETE PAVEMENT SHALL BE REPLACED WITH CONCRETE TO A MINIMUM THICKNESS OF 6" OR TO THE THICKNESS OF REMOVED PAVEMENT, WHICHEVER IS GREATER.
- 3. IF EXISTING BASE MATERIAL IS CTB OR ATB, THEN REPLACEMENT BASE MATERIAL SHALL MATCH EXISTING.
- CONCRETE STRENGTH SHALL BE 3300 PSI AT 28 DAYS.


DRAWN BY: T. KOLLN		CITY OF ST. HELENS	REVISION:
CHECKED BY:		265 THE STRAND, ST.HELENS, OR 97051 PH (503)397-6272 FAX (503)397-4016	NC NC
DATE:		FA (303)397-0272 FAX (303)397-4010	
•	TITLE:		DRAWING NO:
SCALE:		STREET UTILITY PATCH	256

OFFSET CROWN

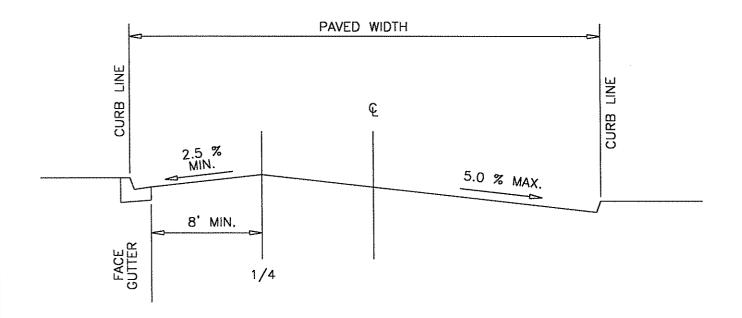

- 1. THE CITY ENGINEER MUST GIVE SPECIFIC APPROVAL FOR USE OF AN OFFSET CROWN.
- 2. OFFSET CROWN CROSS—SECTIONS MAY BE USED IN AREAS OF SUBSTANTIAL CROSS SLOPE.
- OFFSET CROWN CROSS—SECTIONS SHALL NOT BE USED TO INCREASE DESIGN SPEED IN HORIZONTAL CURVES. SUPERELEVATION SECTIONS SHALL BE USED FOR THAT PURPOSE.
- 4. MAXIMUM ELEVATION DIFFERENCE OF CURBS (OR EDGE OF PAVEMENT) IS DETERMINED BY CROSS-SLOPES AND

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DATE:		PH (303)397-6272 FAX (303)397-4016	
	TITLE:		DRAWING NO:
SCALE:		OFFSET CROWN	260

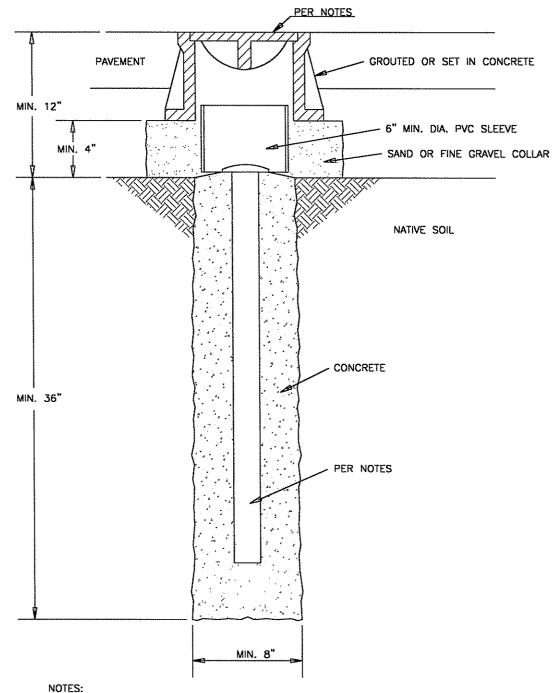

- 1101001
- 1. THIS IS INTENDED FOR GPS OR OTHER CONTROL MONUMENTS.
- 8" x 8" CAST IRON MONUMENT CASTING REQUIRED IN ALL TRAFFIC AREAS (INCLUDING DRIVEWAYS AND PARKING LOTS); IN NONTRAFFIC OR PEDESTRIAN AREAS, A BERNTSEN BMAC-6 OR EQUIVALENT MAY BE SUBSTITUTED.
- 3. THE MONUMENT SHALL BE A 3"-4" DOMED BRASS CAP AFFIXED TO A FERROUS METAL PIPE AT LEAST 30" IN LENGTH. THE CAP SHALL BE STAMPED OR SCRIBED WITH A CLEARLY DEFINED CENTER MARK AND THE FOLLOWING MINIMUM WORDING: "CITY OF ST. HELENS DO NOT DISTURB"


DRAWN BY: CHECKED BY:		CITY OF ST. HELENS 265 THE STRAND, ST. HELENS, OR 97051	REVISION:
DATE:		PH (503)397-6272 FAX (503)397-4016	
	TITLE:		DRAWING NO:
SCALE:	GEODE	TIC MONUMENT - SOFT SOILS	265

TYPE "A"

FOR USE IN INTERSECTIONS, P.I. P.C., P.T.'S


TYPE "B"

FOR USE AT POINTS
ON SOLID ROCK IN
EXISTING ROADWAYS

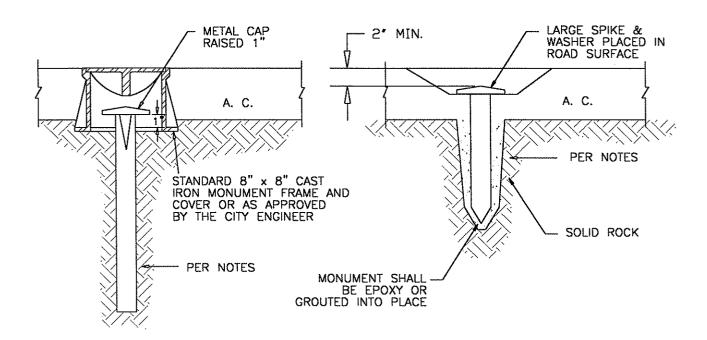


- 1. ALL MONUMENTS SHALL USE EITHER 5/8" DIA. x 30" LONG IRON ROD OR 3/4" DIA. x 30" LONG IRON PIPE, UNLESS APPROVED BY CITY ENGINEER.
- 2. ALL MONUMENTS SHALL BE IN ACCORDANCE WITH CHAPTER 92 AND 209 OF OREGON REVISED STATUES.
- 3. TYPE "A" MONUMENT SHALL BE USED AT CENTERLINE INTERSECTIONS & P.I.'S THAT FALL WITHIN PAVED ROADWAYS IN NEW CONSTRUCTION. IF THE P.I. FALLS OUTSIDE OF THE PAVED ROADWAY THE P.C. AND P.T. WILL BE SET IN LIEU OF THE P.I.
- 4. TYPE "B" MONUMENT WILL BE USED IN SOLID ROCK ONLY.
- 5. ANY POINT BEING USED AS A GPS POINT SHALL BE SET IN ACCORDANCE WITH THE STANDARD "GEODETIC MONUMENT" DETAIL #265.

DRAWN BY: T. KOLLN CHECKED BY: DATE:		CITY OF ST. HELENS 265 THE STRAND, ST. HELENS, OR 97051 PH (503)397-6272 FAX (503)397-4016	REVISION: NC
SCALE:	TITLE:	CENTERLINE SURVEY MONUMENTS	drawing no: 266

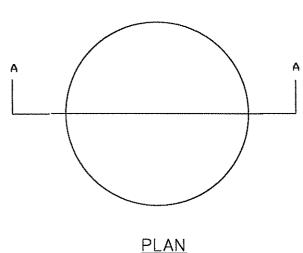


	RISER RING			
	ADJ	USTMEN	IT HEIG	НT
DIM	1 1/2"	2"	2 1/2"	3"
Α	1 1/2"	2"	2 1/2"	3"
В	2 1/4"	2 3/4"	3 1/4"	3 3/4"



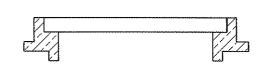


<u>A - A</u>

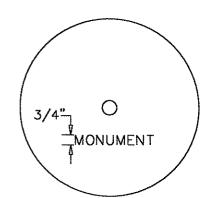

NOTES:

- 1. USE OLYMPIC FOUNDARY PART NO. M1015 OR CITY APPROVED EQUAL
- 2. QUICK SET BAGGED CONCRETE MIX. MINOR STRUCTURE CONCRETE OR CITY APPROVED EQUAL.

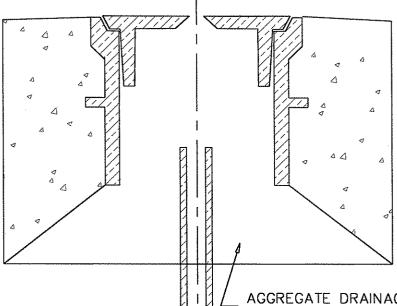

MONUMENT AS REQUIRED TO BE SET BY OTHERS

AGGREGATE DRAINAGE MATERIAL THICKNESS = 4" PLACE AGGREGATE AS

REQUIRED TO SUPPORT MONUMENT BOX DURING CONCRETE PLACEMENT

DRAWN BY: T.L.U. CHECKED BY: DATE:



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MONUMENT BOX


REVISION:


DRAWING NO:

267


SCALE:

Ordinance No. 2875 / April 4, 2003 / Appendix

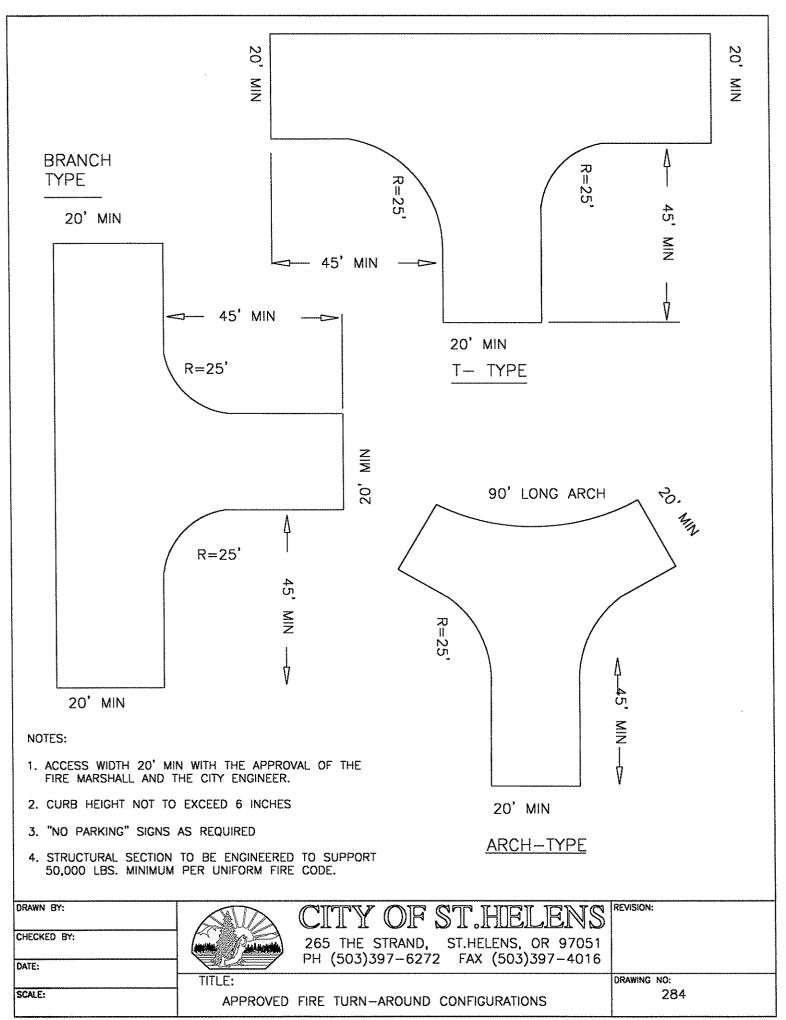

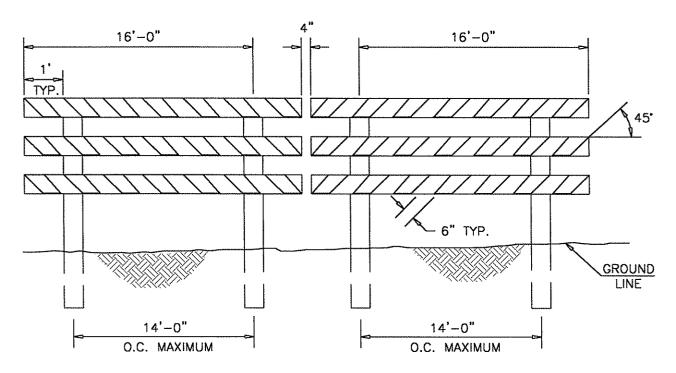

ELEVATION

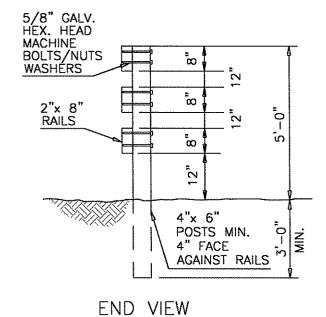


NOTES:

- 1. RAILS TO BE REFLECTORIZED WHITE AND RED STRIPES. POSTS TO BE PRESSURE TREATED.
- 2. SEE MANUAL ON UNIFORM TRAFFIC CONTROL DEVICES FOR STREETS AND HIGHWAYS AND THE OREGON SUPPLEMENT.


3F-1 BARRICADES 6C-8 BARRICADE DESIGN 6C-9 BARRICADE APPLICATION

- 3. ALL MATERIAL AND WORKMANSHIP SHALL BE IN ACCORDANCE WITH THE CURRENT STATE OF OREGON STANDARD SPECIFICATIONS FOR HIGHWAY CONSTRUCTION.
- 4. FOR WIDER APPLICATIONS, MULTIPLE SECTIONS AS SHOWN SHALL BE USED.

DRAWN BY:	MATTA	CITY OF ST HIST FNS	REVISION:
CHECKED BY:		265 THE STRAND, ST.HELENS, OR 97051	
		PH (503)397-6272 FAX (503)397-4016	
DATE:		(000)007 0272 7777 (000)007 1070	
	TITLE:		DRAWING NO:
SCALE:	DOUBLE	STREET BARRICADE - TYPE III	286
	DOODE	_ GIVEET DANSIONEE THE III	

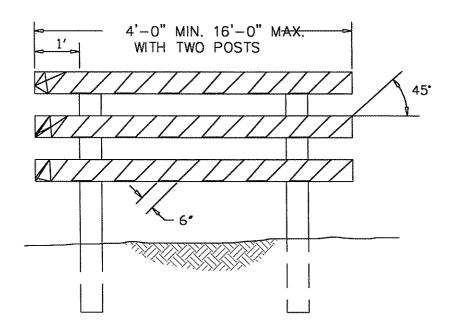

ELEVATION

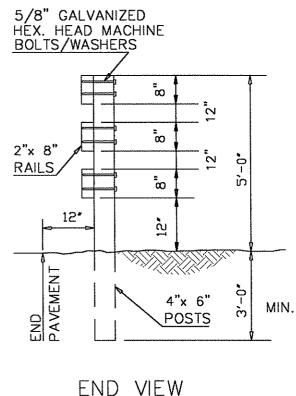

NOTES:


- RAILS TO BE REFLECTORIZED WHITE AND RED STRIPES. POSTS TO BE PRESSURE TREATED.
- 2. SEE MANUAL ON UNIFORM TRAFFIC CONTROL DEVICES FOR STREETS AND HIGHWAYS AND THE OREGON SUPPLEMENT.

3F-1 BARRICADES 6C-8 BARRICADE DESIGN 6C-9 BARRICADE APPLICATION

- 3. ALL MATERIALS AND WORKMANSHIP SHALL BE IN ACCORDANCE WITH THE CURRENT STATE OF OREGON STANDARD SPECIFICATIONS FOR HIGHWAY CONSTRUCTION.
- 4. THE ABOVE BARRICADE INDICATES THAT TRAFFIC PASSES TO THE LEFT OF THE DEVICE. IF TRAFFIC IS TO PASS TO THE RIGHT, THE STRIPES ANGLE MUST REVERSED.
- 5. FOR WIDER APPLICATIONS, MULTIPLE SECTIONS AS SHOWN SHALL BE USED.


DRAWN BY: CHECKED BY:	CITY OF ST. HIELENS	REVISION:
DATE:	265 THE STRAND, ST.HELENS, OR 97051 PH (503)397-6272 FAX (503)397-4016	
	TITLE:	DRAWING NO:
SCALE:	STREET BARRICADE TYPE III — SINGLE	286-A

NOTE: A PERMIT MUST BE OBTAINED FOR ALL WORK TO BE DONE WITHIN RIGHT-OF-WAY FROM THE CITY OF ST. HELENS ENGINEERING DEPARTMENT

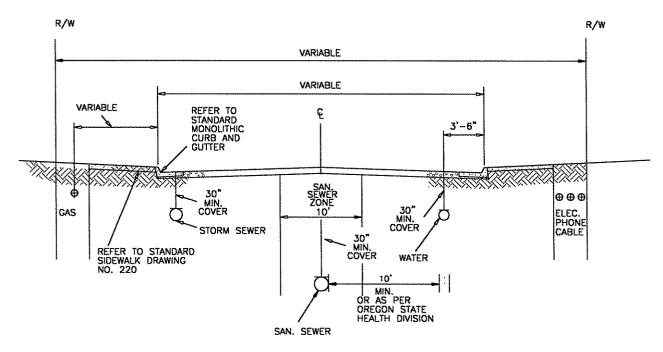


- 1. STORM SEWER AND GAS TO BE LOCATED ON SOUTH/WEST SIDE OF STREET, POWER, COMMUNICATIONS, WATER TO BE LOCATED ON NORTH/EAST SIDE OF STREET.
- 2. ALL UTILITIES SHALL BE INSTALLED AT MINIMUM 30" BELOW ROAD SURFACE TO TOP OF PIPE.
- 3. ALL CROSSINGS SHALL BE MADE USING JACKING METHOD UNLESS PREAPPROVED.
- 4. ALL TRENCHES CROSSING STREETS SHALL BE BACKFILLED & MECHANICALLY COMPACTED TO 2 FEET BELOW SURFACE. COMPACTED 6" LIFTS OF 3/4-0 SHALL BE BROUGHT OT THE SURFACE OF AGG. STREETS OR THE BASE OF PAVED STREETS. ALL TRENCHES SHALL BE PATCHED WITH LIKE MATERIALS TO THE ORIGINAL SURFACE.
- 5. ALL TRENCHES IN SHOULDERS SHALL BE BACKFILLED & MECHANICALLY COMPACTED TO 1 FOOT BELOW SURFACE. COMPACTED LIFTS OF 3/4-0 SHALL BE BROUGHT TO SURFACE.
- 6. ALL STREET PATCHING & SHOULDER REPAIR SHALL BE WARRANTIED FOR 1 YEAR.

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DATE:	PH (303)397-0272 FAX (303)397-4016	
	TITLE:	DRAWING NO:
SCALE:	STANDARD UTILITY LOCATIONS	295

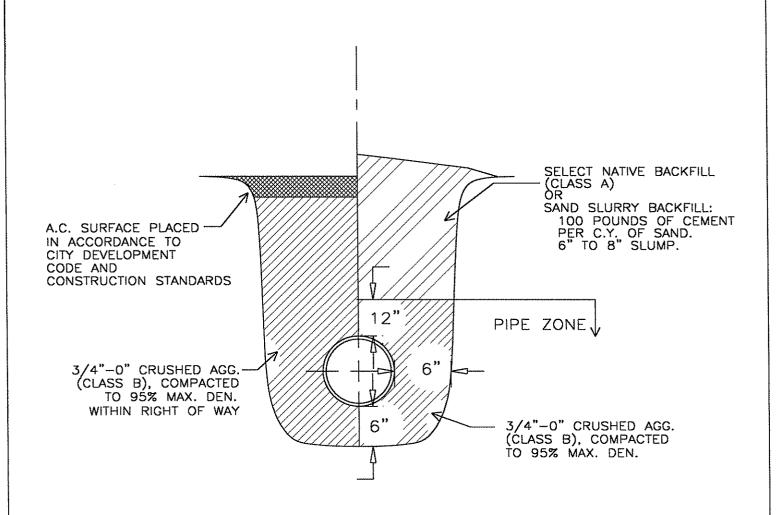


1. MINIMUM TRENCH WIDTH IS 24-INCHES (SEE APWA SEC 301.3)

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CHECKED BY:		265 THE STRAND, ST. HELENS, OR 97051	
DATE:		PH (503)397-6272 FAX (503)397-4016	
	TITLE:		DRAWING NO:
SCALE:		TYPICAL TRENCH DETAIL	300

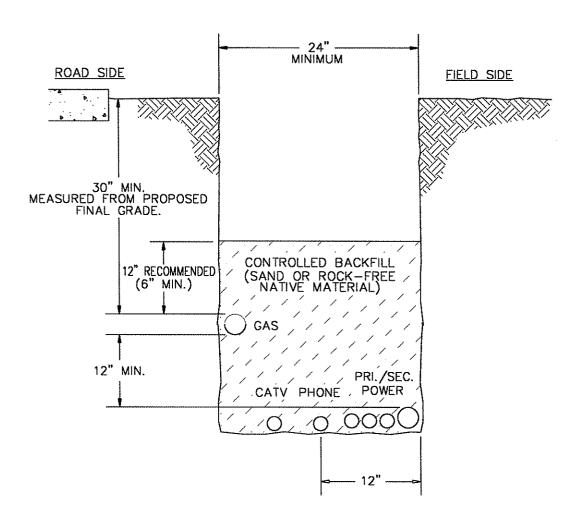


TRENCH REQUIREMENTS FOR JOINT UTILITY USE MAIN EXTENSION OREGON

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		CITY OF ST.HELENS	
CHECKED BY:	KOWE		
Oncored on	A STATE OF THE STA	265 THE STRAND, ST.HELENS, OR 97051	
		PH (503)397-6272 FAX (503)397-4016	
DATE:		FIT (303)397-0272 FAX (303)397-4010	
	TITLE:		DRAWING NO:
SCALE:		JOINT UTILITY TRENCH	301
'		JUNI CHEHI IKENCH	301
			1

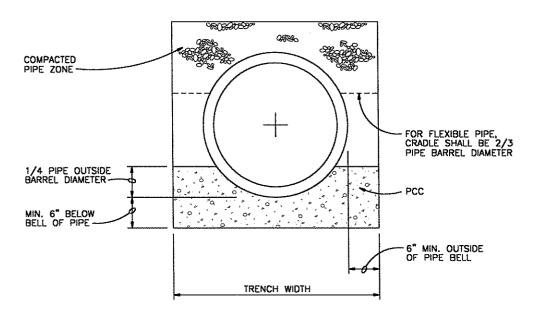

ENCASEMENT DETAIL

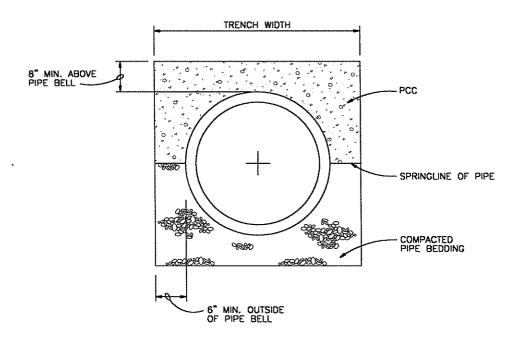


CAP DETAIL

NOTE:

THE CONCRETE SHALL BE CLASS 2000 MINIMUM.


DRAWN BY: T. KOLLN CHECKED BY: DATE:		CITY OF ST. HELENS 265 THE STRAND, ST. HELENS, OR 97051 PH (503)397-6272 FAX (503)397-4016	revision: NC
SCALE:	TITLE:	CONCRETE CRADLE AND CAP DETAIL	drawing no: 305

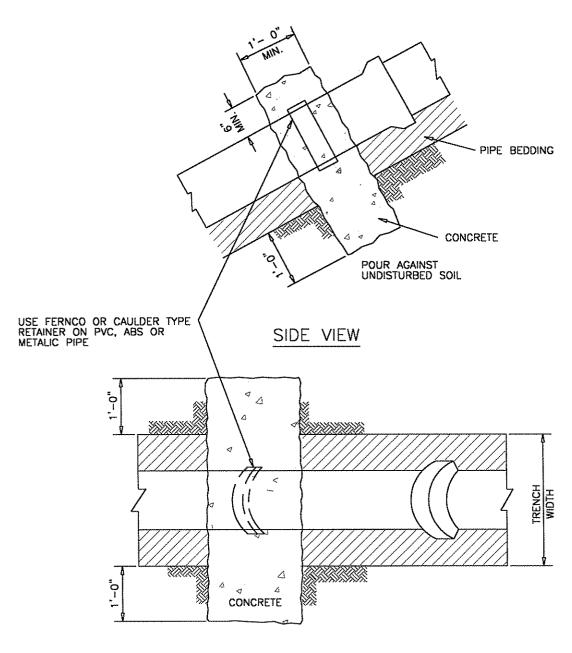


PLAN

SLOPE	MIN. ANCHOR SPACING, CENTER TO CENTER
0.20-0.34	35'
0.35-0.50	25'
0.51+	15' OR CONC. ENCASEMENT

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DATE:		
SCALE:	TITLE: STEEP SLOPE PIPE ANCHOR WALLS	DRAWING NO:

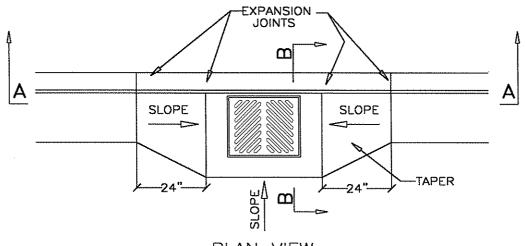


PLAN VIEW

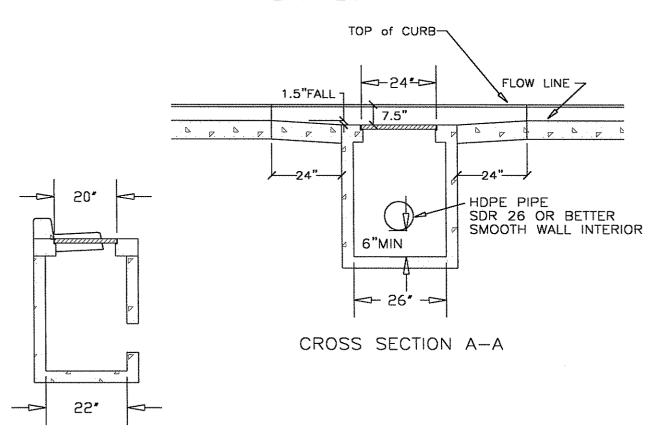


CROSS SECTION B-B


NOTE:
USES WSDOT STD STYLE "C-2" GRATE

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SCALE:	TITLE:	TYPICAL 20"X24" CATCH BASIN	DRAWING NO: 315

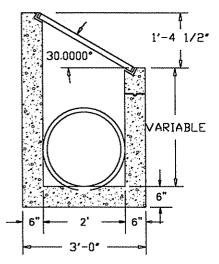


SECTION A - A

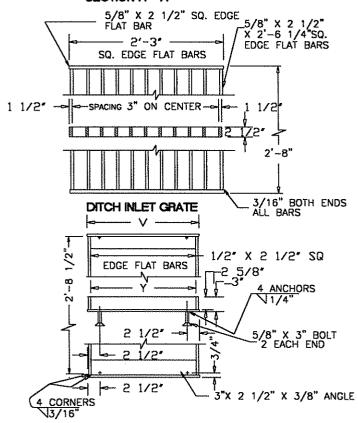

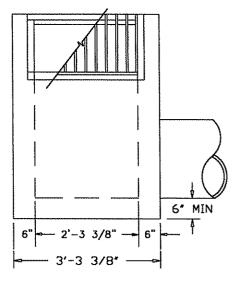

SECTION B - B

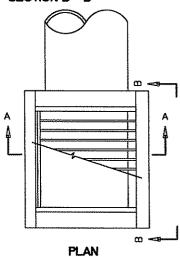

NOTES:

- 1. CONCRETE STRENGTH SHALL BE 3000 PSI.
- G-2 GRATES MAY BE USED IF APPROVED BY THE ENGINEER. CATCH BASIN, FRAME, AND GRATES SHALL MEET H20 LOADING.
- INSIDE FRAME DIMENSIONS: 2'-3 3/8", 2'-8 1/2."


NOTE:

3/8" CROSS BARS SHALL BE FLUSH WITH THE GRATE SURFACE AND MAY BE FILLET WELDED, RESISTANCE WELDED OR ELECTROFORGED TO BEARING BARS.


DITCH INLET FRAME


	INLET TYPE	V	Y	Y ₁ OF	NO. BARS	TYPE
1	D	2'-4 3/4"	2'-3 3/8"	2'-3"	9	1

DRAWN BY: REVISION: T. KOLLN CHECKED BY: NC 265 THE STRAND, ST.HELENS, OR 97051 PH (503)397-6272 FAX (503)397-4016 DATE: TITLE: DRAWING NO: DITCH INLET SCALE: 325

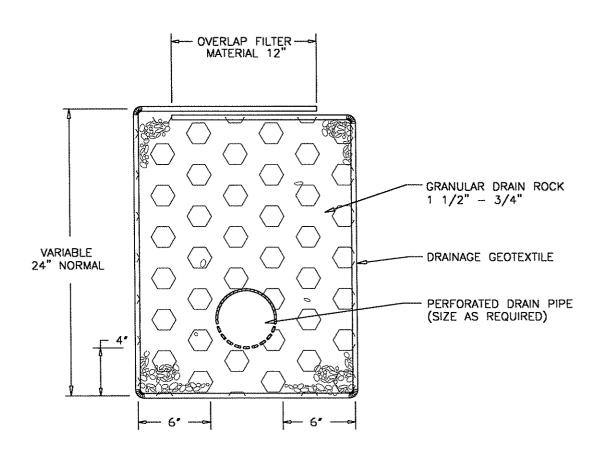


DRAWN BY: T. KOLLN CHECKED BY: DATE:			ST.HELENS ST.HELENS, OR 97051 FAX (503)397-4016	NC
SCALE:	TITLE:	SUBSURFACE	DRAIN	DRAWING NO: 330

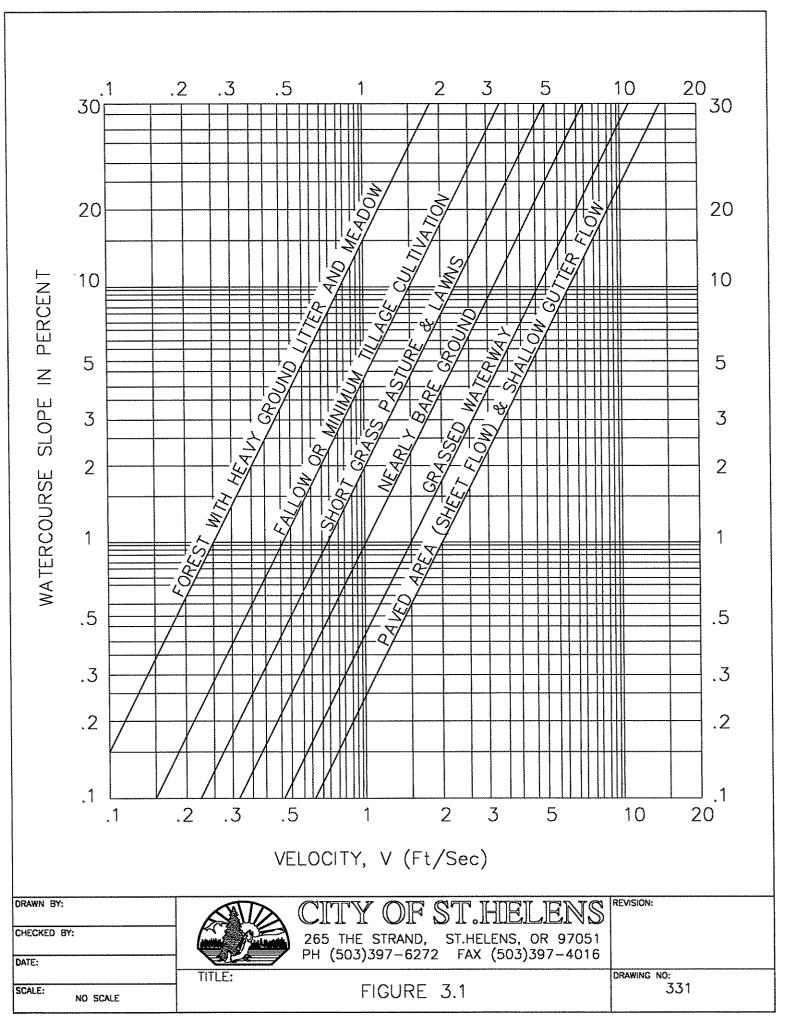


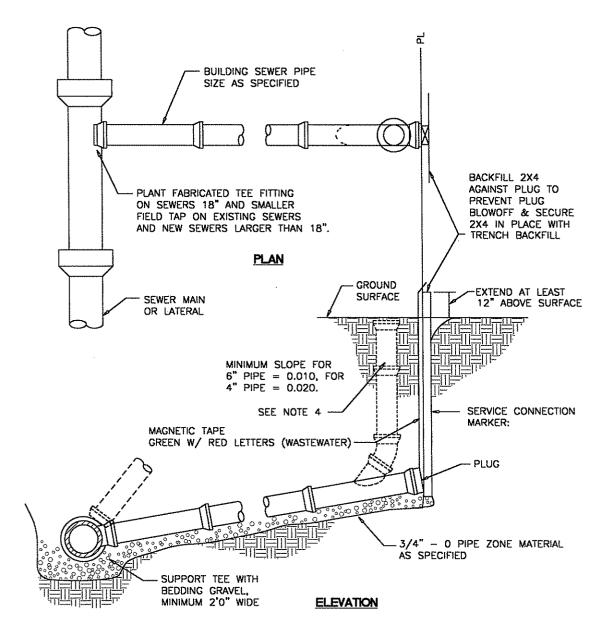

- PIPE AND FITTINGS SHALL BE COMPATIBLE. ONLY MANUFACTURED FITTINGS SHALL BE USED.
- MINIMUM DEPTH AT RIGHT OF WAY OR EASEMENT LINE SHALL BE 4 FEET.
- 3. MARKER POSTS AND BLOCKING SHALL BE TREATED WOOD.
 POST SHALL BE 2" x 4" FIR. POST TO EXTEND 12"
 MINIMUM ABOVE FINISH GRADE AND EXPOSED AREA
 SHALL BE PAINTED WHITE.
- 4. WHEN REQUIRED, A CLEANOUT SHALL BE INSTALLED.
- 5. LAY BUILDING SEWER AT MAX. 45° FROM HORIZONTAL TO ACHIEVE REQUIRED DEPTH AT PROPERTLY LINE WHEN MINIMUM SLOPE RESULTS IN EXCESSIVE DEPTH.


DRAWN BY: T. KOLLN CHECKED BY: DATE:	CITY OF ST. HIELENS 265 THE STRAND, ST. HELENS, OR 97051 PH (503)397-6272 FAX (503)397-4016	REVISION: NC
SCALE:	TITLE: SHALLOW TRENCH SERVICE CONNECTION, BLOCKING, & MARKING	drawing no: 335

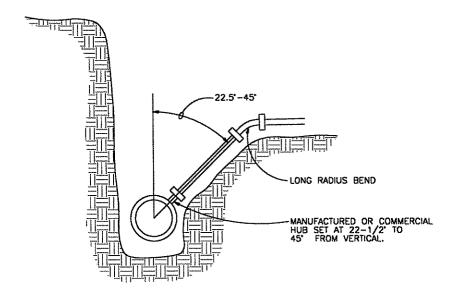

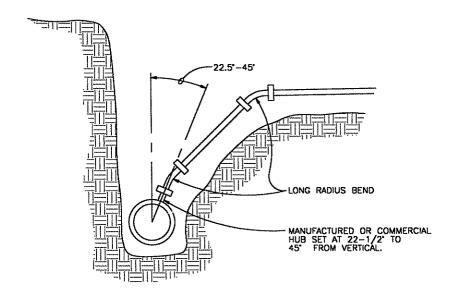


- 1. PIPE AND FITTINGS SHALL BE COMPATIBLE. ONLY MANUFACTURED FITTINGS SHALL BE USED.
- 2. MINIMUM DEPTH AT RIGHT OF WAY OR EASEMENT LINE SHALL BE 4 FEET.
- 3. PLUGGING, BLOCKING, AND MARKING OF UNCONNECTED SERVICES SHALL CONFORM TO SHALLOW TRENCH SERVICE CONNECTION DRAWING.
- 4. VERTICAL TRENCH WALLS ARE REQUIRED. IF IT IS NOT POSSIBLE TO MAINTAIN VERTICAL TRENCH WALLS, USE ALTERNATE CONNECTION METHOD TO MAINTAIN 6" MAXIMUM DISTANCE BETWEEN RISER PIPE AND TRENCH WALLS. REPLACE ALL EXCAVATED OR DISTURBED MATERIAL WITH FULL DEPTH GRANULAR BACKFILL COMPACTED TO 95% RELATIVE DENSITY.
- 5. WHERE DEEP CONNECTION IS AT AN ANGLE LESS THAN 45' FROM VERTICAL, DUCTILE IRON PIPE AND FITTINGS SHOULD BE USED.


DRAWN BY: T. KOLLN	CITY OF ST.HELENS	REVISION:
CHECKED BY:	265 THE STRAND, ST.HELENS, OR 97051 PH (503)397-6272 FAX (503)397-4016	NC
DATE:	FIT (303)397-0272 TAX (303)397-4010	
	TITLE:	DRAWING NO:
SCALE:	TYPICAL DEEP TRENCH SERVICE CONNECT DETAIL	336

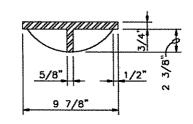


CAST IRON COVER

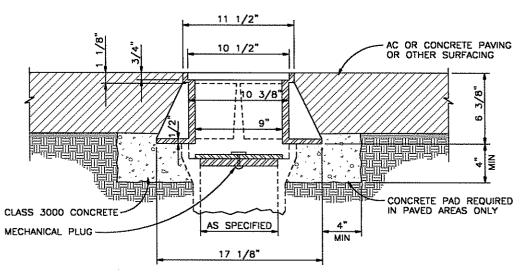


CAST IRON FRAME

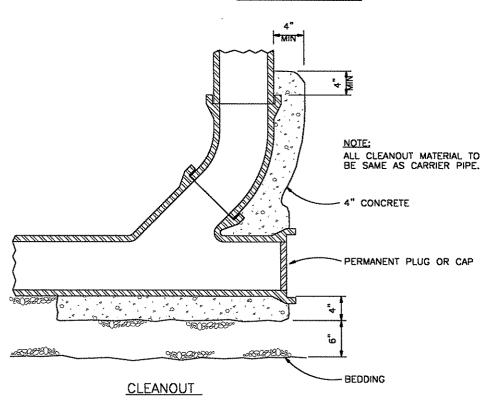

DRAWN BY: T. KOLLN CHECKED BY: DATE:		CITY OF ST. HELENS 265 THE STRAND, ST. HELENS, OR 97051 PH (503)397-6272 FAX (503)397-4016	REVISION:
SCALE:	TITLE:	CLEANOUT DETAIL	DRAWING NO: 340

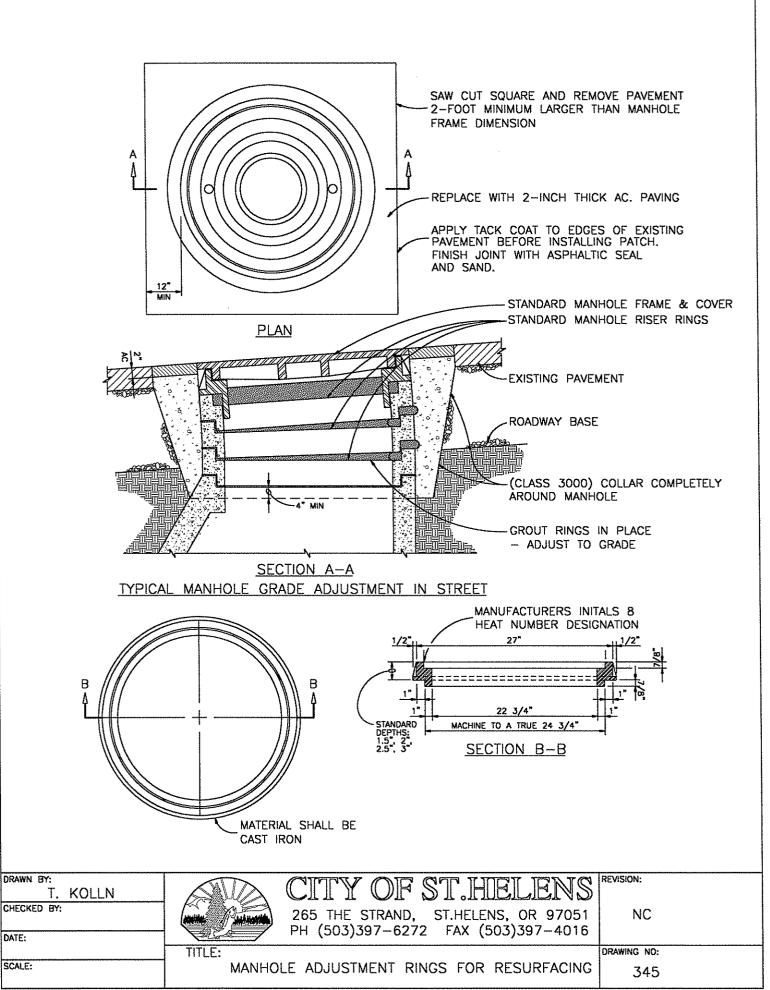


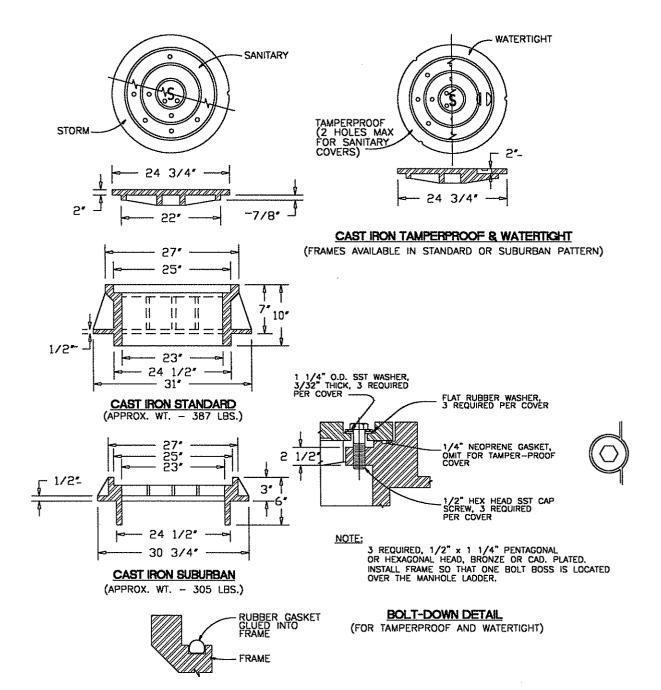

WATERTIGHT GASKET DETAIL


- 1. TAMPERPROOF COVERS REQ'D ON SANITARY OR STORM DRAIN MANHOLE WHERE LOCATED IN PEDESTRIAN WAYS OR EASMENT AREAS. TAMPERPROOF COVERS FOR SANITARY MANHOLES SHALL HAVE 2 HOLES MAXIMUM.
- 2. WATERTIGHT COVERS REQUIRED IF LOCATED WHERE COVER MAY BE SUBMERGED.
- 3. FRAMES AND COVERS SHALL BE STAMPED WITH MANUFACTURER'S INITIALS, HEAT NUMBER AND POINT OF ORIGIN.

DRAWN BY: T. KOLLN CHECKED BY: . DATE:		CITY OF ST. HELENS 265 THE STRAND, ST. HELENS, OR 97051 PH (503)397-6272 FAX (503)397-4016	REVISION: NC
SCALE:	TITLE:	MANHOLE COVER & FRAME DETAILS	DRAWING NO: 346

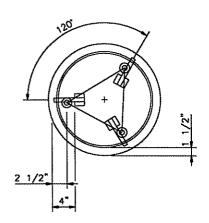


NOTE:
BOLTS TO BE FURNISHED WITH STANDARD
HEX-HEAD NUTS & COTTER KEYS. COVER
AND RING TO BE MACHINED TO A TRUE
BEARING AT CONTACT POINTS.


<u>PLAN</u>

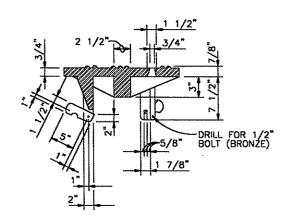

COVER SECTION

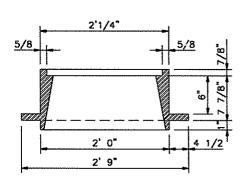


FRAME SECTION

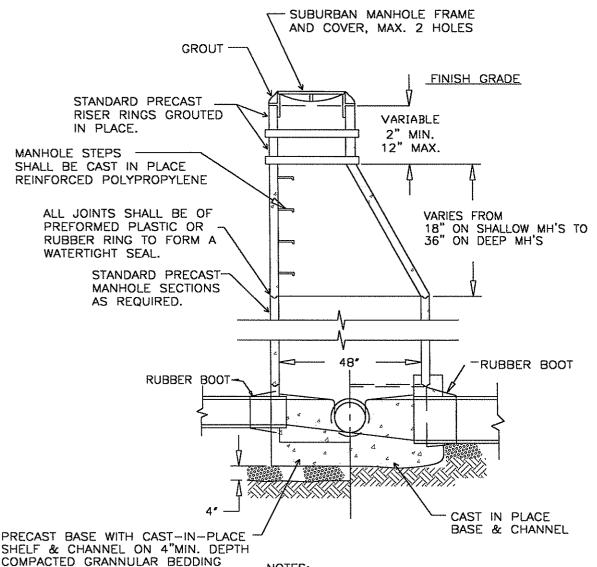

- 1) STANDARD PRECAST MANHOLE SECTIONS ASTM C478 USE 48" MINIMUM FOR PIPE SIZES TO 30" MAXIMUM USE 60" MINIMUM FOR PIPE SIZES TO 42" MAXIMUM USE 72", 84", OR 102" WHEN SPECIFIED.
- 2) USE ECCENTRIC PRECAST CONE FOR ALL MANHOLES OVER FOUR FEET DEEP.
- 3) PIPE CONNECTIONS SHALL CONFORM WITH DIVISION 3 OF THE APWA STANDARDS
- 4) FRAME AND RISER RINGS SHALL BE SEALED WITH PREFORMED PLASTIC OR RUBBER TO FORM A WATERTIGHT SEAL. GROUT MAY BE USED FOR STORM SYSTEMS.


DRAWN BY: T. KOLLN CHECKED BY: . DATE:		CITY OF ST. HELENS 265 THE STRAND, ST. HELENS, OR 97051 PH (503)397-6272 FAX (503)397-4016	REVISION:
SCALE:	TITLE:	TYPICAL MANHOLE DETAIL	DRAWING NO: 350

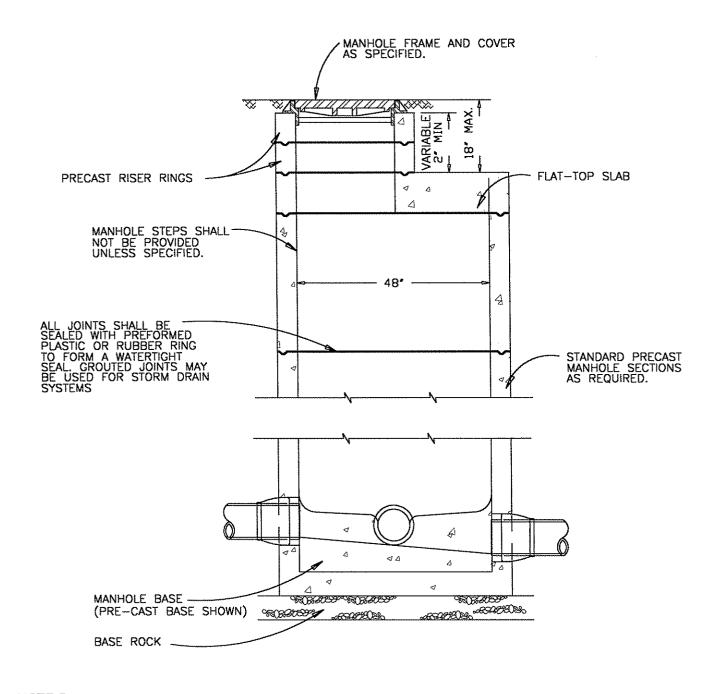

NOTE:S


- 1. SEE MANHOLE BASE SECTION DRAWING FOR BASE DETAILS
- 2. MANHOLE MAY BE 42" DIAMETER IF DIRECTED BY ENGINEER.
- 3. REFER TO STANDARD MANHOLE DETAIL.
- 4. FRAME AND RISER RINGS SHALL BE SEALED WITH PREFORMED PLASTIC OR RUBBER TO FORM A WATERTIGHT SEAL. GROUT MAY BE USED FOR STORM SYSTEMS.

DRAWN BY: T. KOLLN		CITY OF ST. HELENS	REVISION:
CHECKED BY:		265 THE STRAND, ST.HELENS, OR 97051 PH (503)397-6272 FAX (503)397-4016	NC
DATE:		111 (303)331 0212 TAX (303)331 4010	
	TITLE:		DRAWING NO:
SCALE:		FLAT-TOP MANHOLE	351

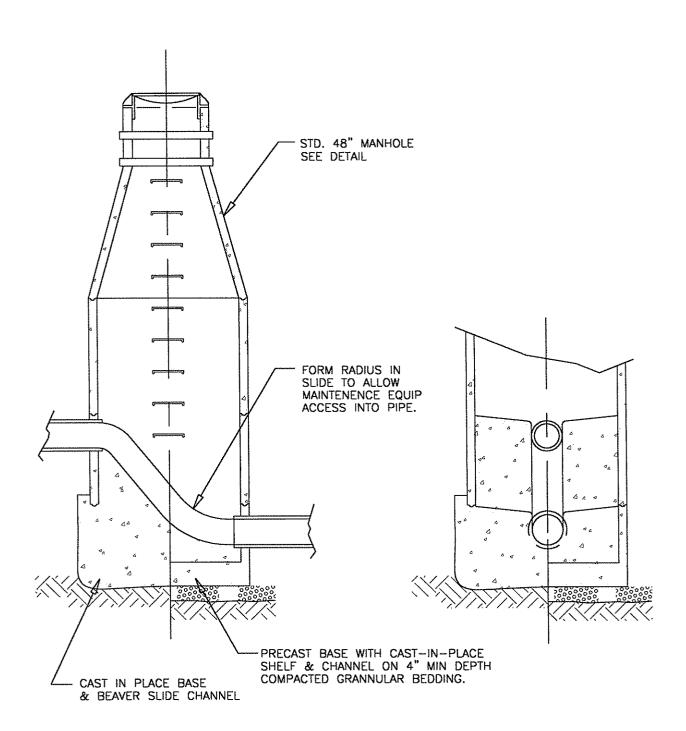

REFER TO TYP. MANHOLE DETAIL NO. 350

DRAWN BY: T. KOLLN CHECKED BY: . DATE:		CITY OF ST. HELENS 265 THE STRAND, ST. HELENS, OR 97051 PH (503)397-6272 FAX (503)397-4016	REVISION: NC
SCALE:	TITLE:	BEAVER SLIDE MANHOLE	DRAWING NO: 352

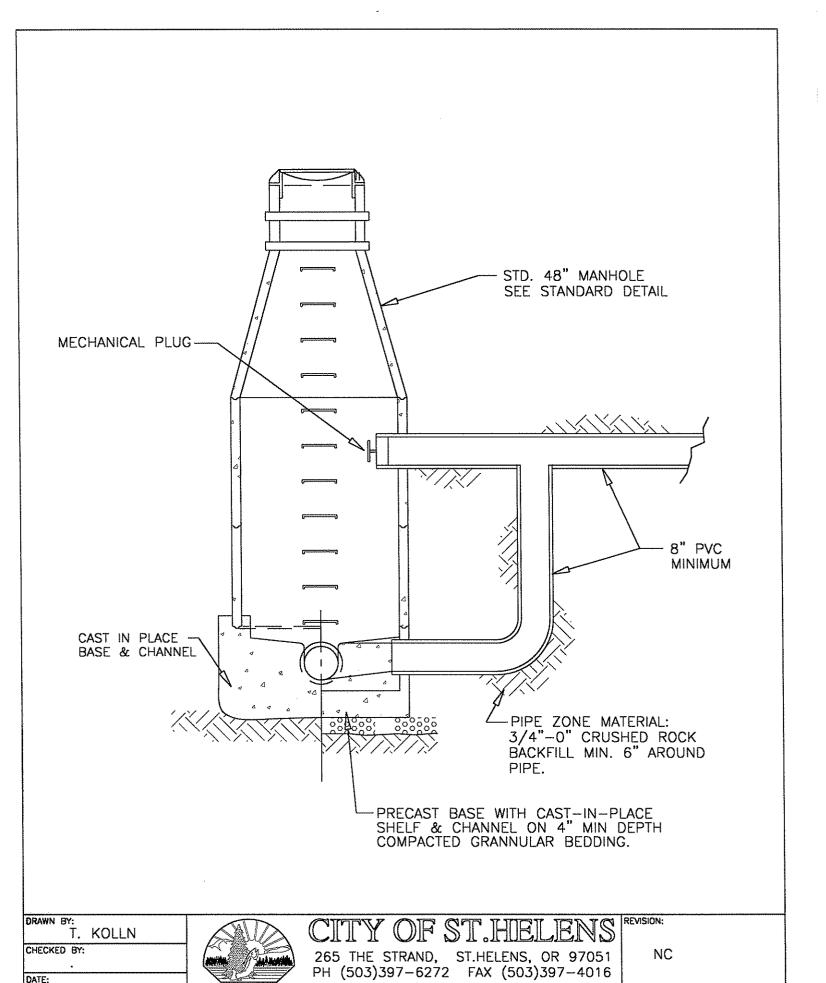

TYPICAL OUTSIDE DROP MANHOLE DETAIL


DRAWING NO:

353

Ordinance No. 2875 / April 4, 2003 / Appendix


TITLE:

SCALE:

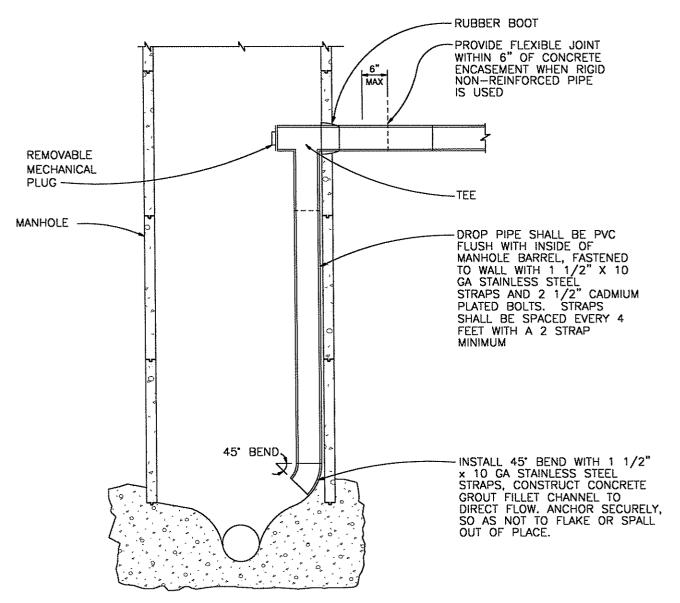


- ONLY ONE INSIDE DROP CONNECTION ALLOWED PER MANHOLE.
- 2. MINIMUM MANHOLE DIAMETER WITH DROP CONNECTION SHALL BE 48-INCHES.
- 3. MAXIMUM DROP PIPE DIAMETERR SHALL BE 8-INCHES.
- 4. REFER TO TYPICAL MANHOLE DETAIL

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SCALE:	TITLE:	INSIDE DROP MANHOLE	drawing no: 354

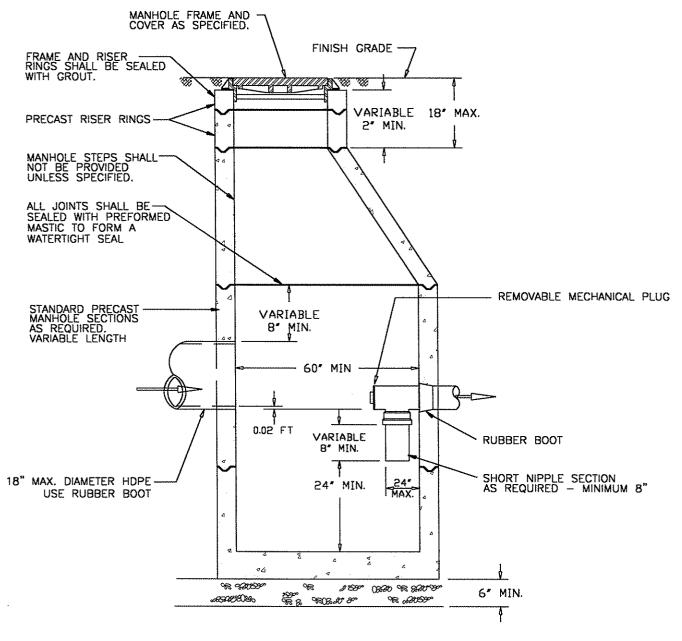


- ALL PRECAST SECTIONS SHALL CONFORM TO REQUIREMENTS OF ASTM C 478.
- ALL CONNECTING PIPE SHALL HAVE A FLEXIBLE JOINT WITHIN 18" OF MANHOLE WALL.


DRAWN BY: T. KOLLN CHECKED BY: . DATE:	CITY OF ST. HELENS 265 THE STRAND, ST. HELENS, OR 97051 PH (503)397-6272 FAX (503)397-4016 REVISION: NC
SCALE:	TITLE: POLLUTION CONTROL MANHOLE INSIDE ELBOW 355

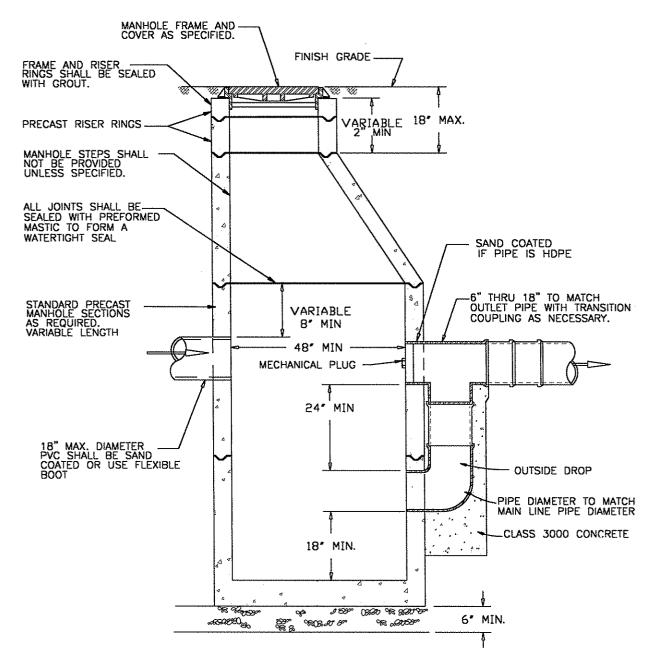


- ALL PRECAST SECTIONS SHALL CONFORM TO REQUIREMENTS OF ASTM C 478.
- 2. ALL CONNECTING PIPE SHALL HAVE A FLEXIBLE JOINT WITHIN 18" OF MANHOLE WALL. IF THE PIPE IS HDPE, IT SHALL BE EPOXY-SAND COATED WHERE IT IS GROUTED INTO THE MANHOLE.
- CONSTRUCT OUTSIDE DROP PER THE DETAIL FOR 'TYPICAL OUTSIDE DROP MANHOLE'.

DRAWN BY: T. KOLLN CHECKED BY:	CITY OF ST. HELENS 265 THE STRAND, ST. HELENS, OR 97051 PH (503)397-6272 FAX (503)397-4016 NC
DATE:	11. (000)007. 02.72 17.10 (000)007. 10.70
•	TITLE: DRAWING NO:
SCALE:	POLLUTION CONTROL MANHOLE OUTSIDE ELBOW 356
•	

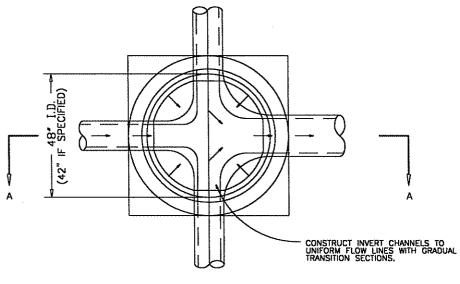

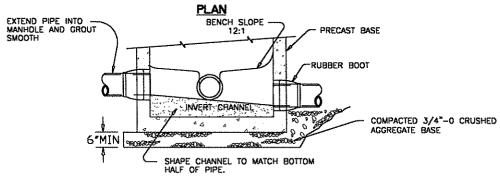

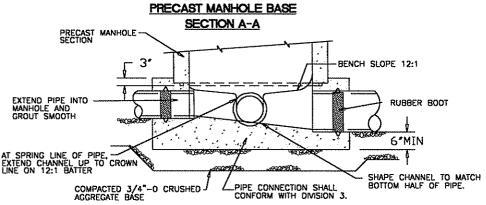


CAST -IN-PLACE MANHOLE BASE


NOTES:

SECTION A-A

- 1. CONCRETE SHALL BE 3300 PSI AT 28 DAYS.
- 2. CHANNELS SHALL BE CONSTRUCTED TO PROVIDE SMOOTH SLOPES AND RADII TO OUTLET PIPE.
- 3. BASES MAY BE PRECAST OR POURED IN PLACE.
- 4. THIS MANHOLE BASE SECTION SHALL BE USED FOR PIPE SIZES UP TO 24".
- 5. USE RUBBER BOOTS IF PIPE IS FLEXIBLE. BOOTS MAY BE KOR-N-SEAL OR EQUIVALENT.

T. KOLLN		CITY OF ST. HELENS	REVISION:
CHECKED BY:		265 THE STRAND, ST.HELENS, OR 97051 PH (503)397-6272 FAX (503)397-4016	NC
DAIL:	TITLE:		DRAWING NO:
SCALE:		MANHOLE BASE SECTION	360

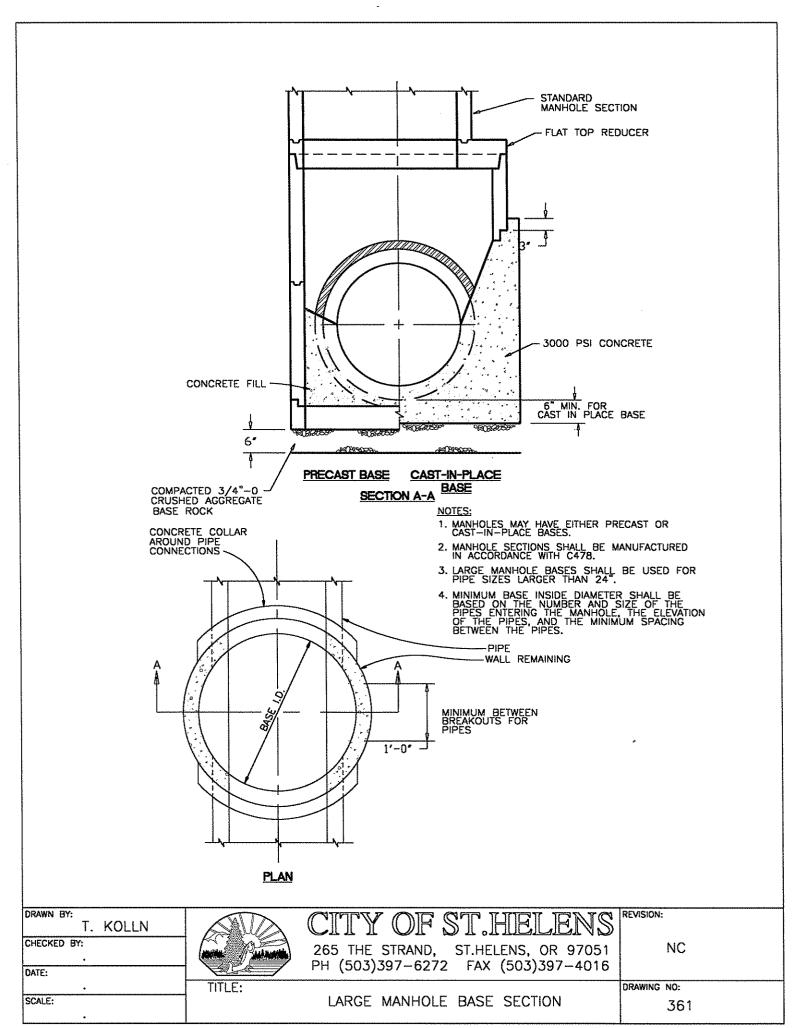

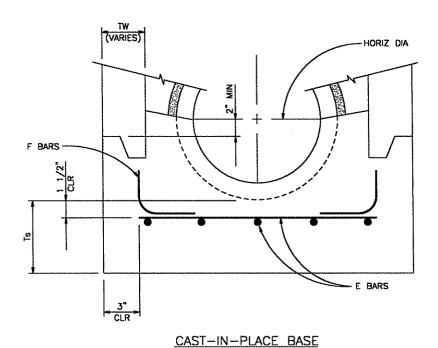


BASE	I.D.	60)"	7:	2"	8-	4"	90	3"
TYPE	DEPTH*	0'-15'	15'30'	0'-15'	15'30'	0'15'	15'-30'	0'15'	15'30'
CAST	Ts	7.0"	9.0"	7.0*	9.0*	8.0*	10.0*	9.0"	11.0"
CAST IN PLACE	E BARS	#4 © 12"	#4 © 9"	#4 © 9"	#4 © 6"	#4 ⊕ 8"	#5 6 9 9"	#4 © 7"	#5 © 8"
PLACE	F BARS	#4 @ 12"	#4 ⊕ 9"	#4 © 9"	#4 © 6"	#4 © 8"	#5 6 9"	#4 © 7"	#5 6 9 8*

*INVERT TO STREET GRADE


 $\frac{\text{NOTE};}{\text{CONCRETE}}$ SHALL BE CLASS 3000. STEEL fg = GRADE 60.


T. KOLLN	CITY OF ST.HELENS	REVISION:
CHECKED BY:	265 THE STRAND, ST.HELENS, OR 97051 PH (503)397-6272 FAX (503)397-4016	NC
DATE:	PH (303)397-6272 FAX (303)397-4016	
v	TITLE:	DRAWING NO:
SCALE:	LARGE CAST-IN-PLACE CONCRETE MANHOLE BASE	362

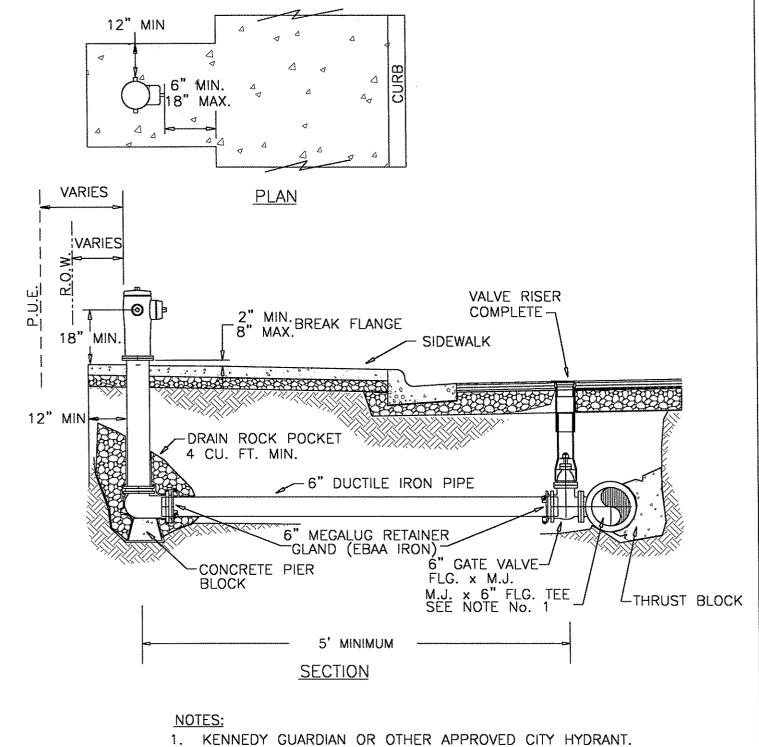

- 1. KENNEDY GUARDIAN OR OTHER APPROVED CITY HYDRANT (VARIFY APPROVED HYDRANTS WITH CITY OF ST. HELENS MAINTENANCE DEPT. @ 503-397-3532)
- 2. NO OBSTRUCTIONS WITHIN 3 FT. OF FIRE HYDRANT
- 3. SIDEWALK SHALL BE WIDENED AROUND FIRE HYDRANT
- 4. INSTALL 3-FT X 3-FT X 8-IN PCC RESTRAINT COLLAR WHEN NOT WITHIN PCC SIDEWALK


DRAWN BY: T. KOLLN	CITY OF ST. HIELENS	REVISION:
CHECKED BY: DATE:	265 THE STRAND, ST.HELENS, OR 97051 PH (503)397-6272 FAX (503)397-4016	NC
SCALE:	TITLE: FIRE HYDRANT INSTALLATION	DRAWING NO: 400

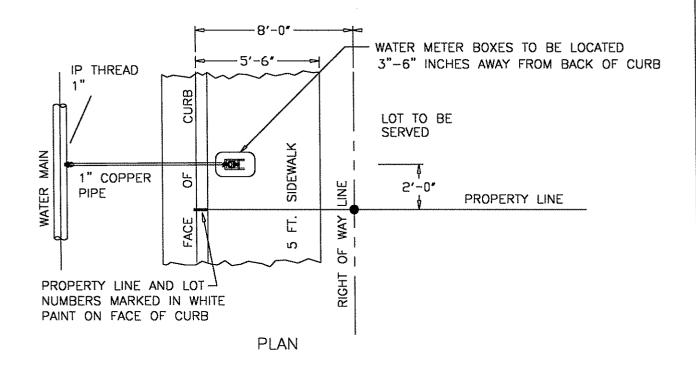


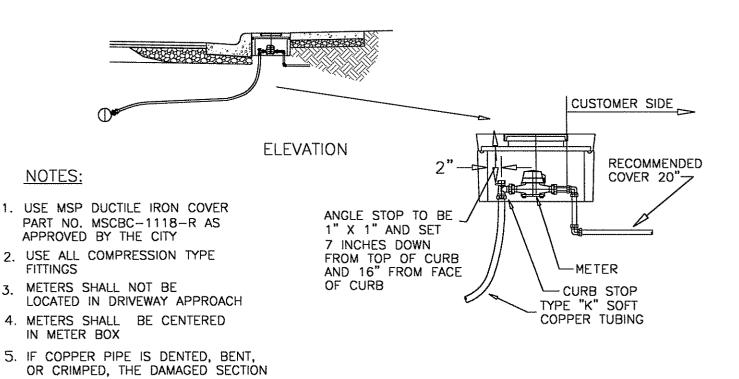

DRAWN BY: T. KOLLN CHECKED BY: DATE: TITLE: CHECKED BY: 265 THE STRAND, ST.HELENS, OR 97051 PH (503)397-6272 FAX (503)397-4016 DRAWING NO: SCALE: SINGLE WATER SERVICE INSTALLATION 405


SHALL BE REMOVED

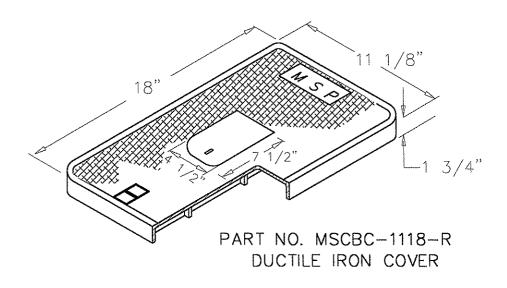

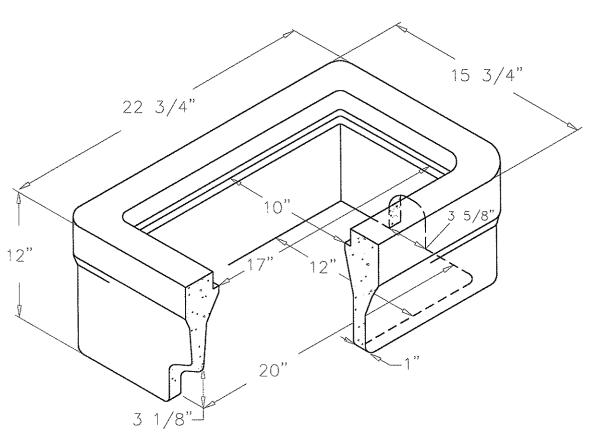

- 1. NO. 37 BODY WITH DUCTILE IRON COVER
- 2. LIGHTWEIGHT (LR) BOXES NOT ACCEPTABLE


DRAWN BY: SJNM	CITY OF ST. HELENS	REVISION:
CHECKED BY:	265 THE STRAND, ST.HELENS, OR 97051	
DATE:	PH (503)397-6272 FAX (503)397-4016	
	TITLE:	DRAWING NO:
SCALE: NOT TO SCALE	BROOKS 12" X 20" METER BOX FOR 1" WATER METER	406

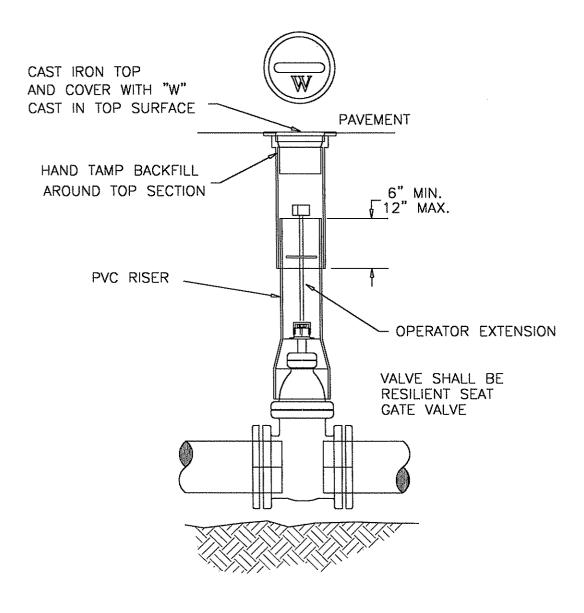


- 1) VALVE BOX NOT TO REST ON OPERATING ASSEMBLY.
- 2) OPERATOR EXTENSION
 REQUIRED WHEN VALVE NUT
 IS DEEPER THAN 3 FEET
 FROM FINISHED GRADE.
- CENTER VALVE BOX ON AXIS OF OPERATOR NUT.


- 4) PROVIDE 24" SQUARE BY 4" THICK CONCRETE PAD AROUND VALVE BOX OUTSIDE OF PAVED AREAS.
- 5) ALL VALVES AND FITTINGS SHALL BE MECHANICAL JOINT.
- 6) SEE STANDARD DETAIL FOR FLANGE UP VALVE BOX AND COVER.

DRAWN BY: T. KOLLN		CITY OF ST. HELENS	REVISION:
CHECKED BY:		265 THE STRAND, ST.HELENS, OR 97051 PH (503)397-6272 FAX (503)397-4016	NC
DATE:		FN (303)397-0272 FAX (303)397-4010	
SCALE:	TITLE:	GATE VALVE SETTING DETAIL	DRAWING NO: 410
JWALE:			410

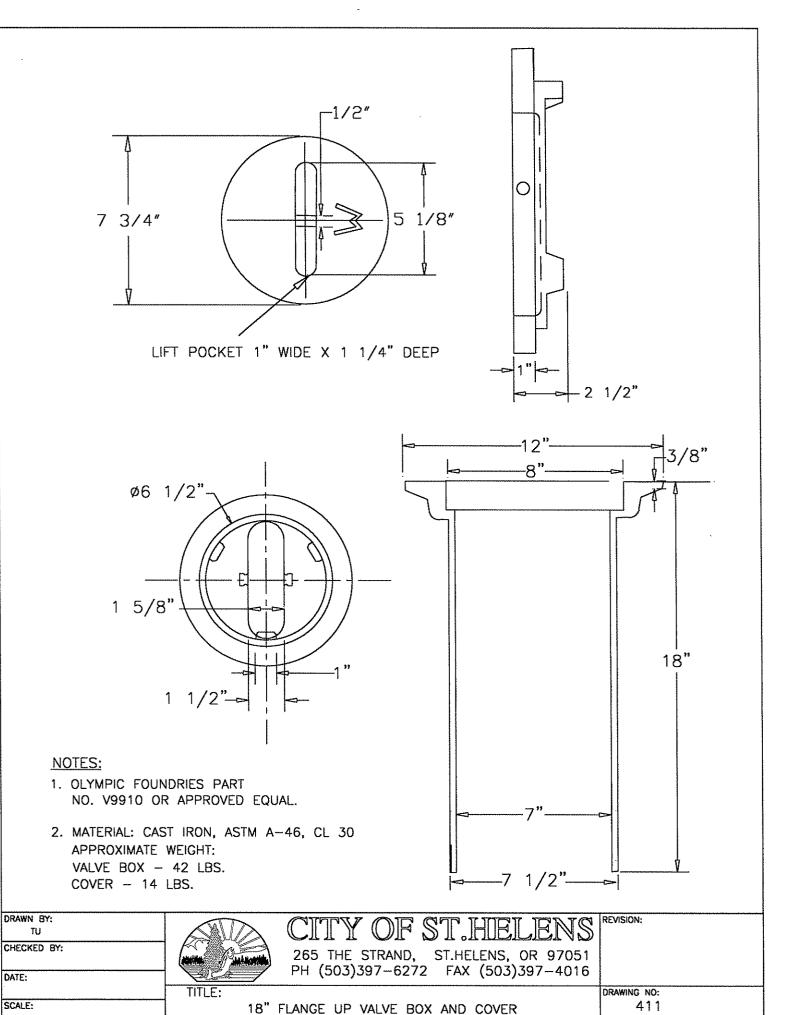

DATE:

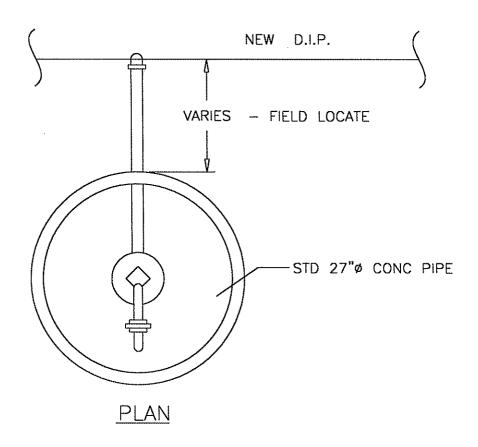

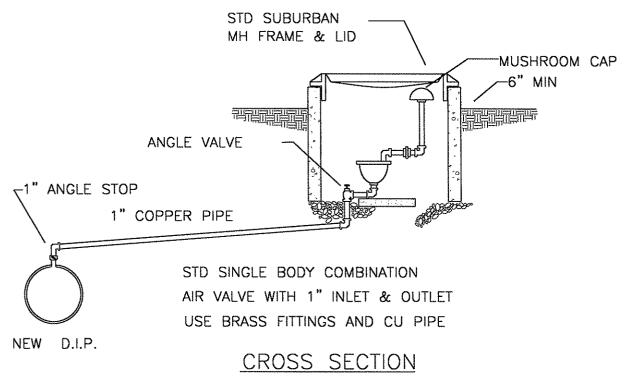

DRAWN BY:

T. KOLLN

CHECKED BY:

DATE:

AIR RELEASE VALVE

TITLE:

CITY OF ST. HELENS


REVISION:


NC


NC

DRAWING NO:

415

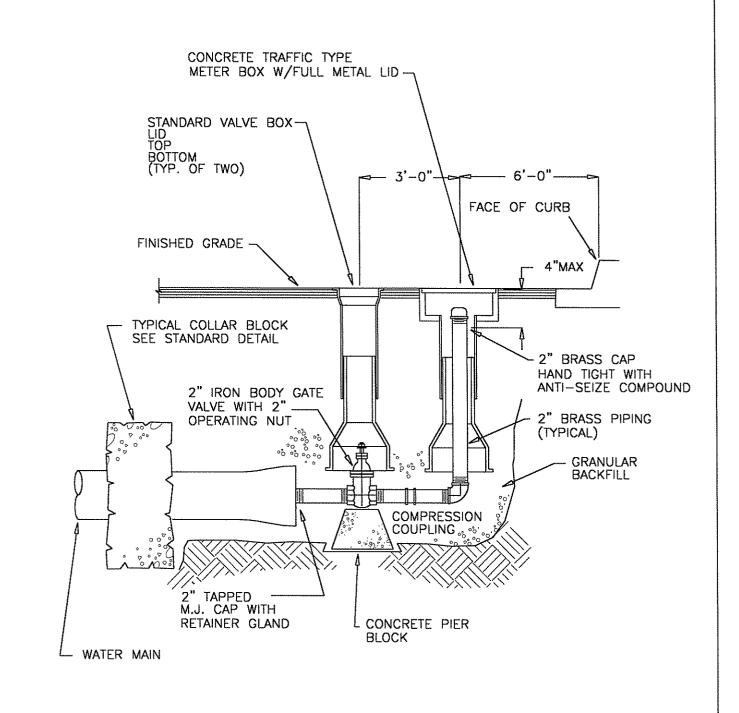


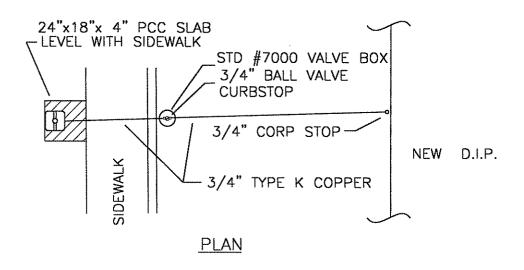


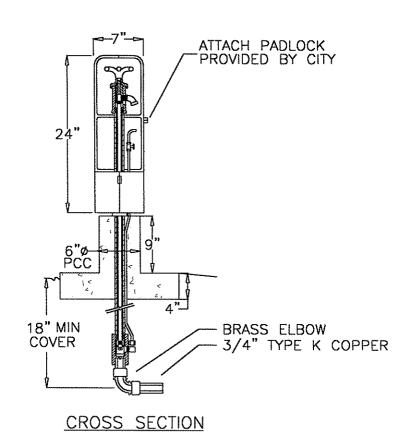

KUPFERLE FOUNDRY OR PRE-APPROVED EQUAL ONLY


DRAWN BY: T. KOLLN CHECKED BY: . DATE:		CITY OF ST. HIELENS 265 THE STRAND, ST. HELENS, OR 97051 PH (503)397-6272 FAX (503)397-4016	REVISION:
SCALE:	TITLÉ:	ELIPSE #88 SAMPLING STATION	DRAWING NO: 421

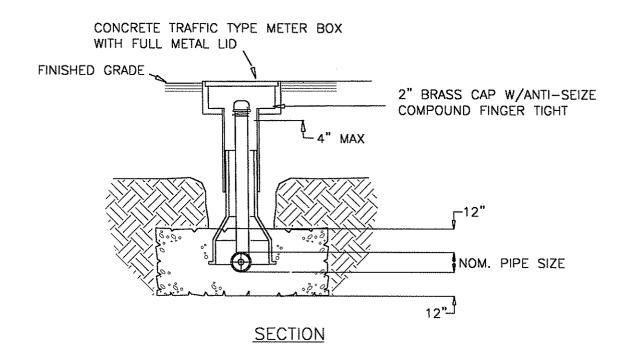

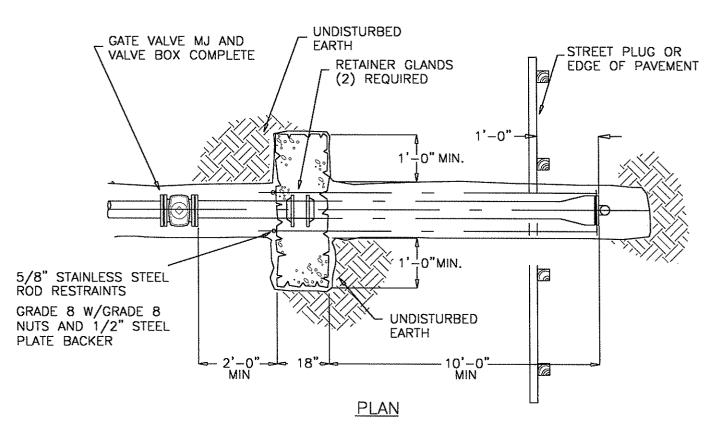


KEY COLLAR BLOCK INTO TRENCH SIDES AND BOTTOM A MINIMUM OF 1'-0"

DRAWN BY: T. UNDERWOOD		CITY OF ST. HIELENS	REVISION:
CHECKED BY:	Pulsana Pulsana	265 THE STRAND, ST.HELENS, OR 97051 PH (503)397-6272 FAX (503)397-4016	
DATE:		PH (303)397-6272 FAX (303)397-4016	
	TITLE:		DRAWING NO:
SCALE:		TEMPORARY 2" BLOWOFF	422

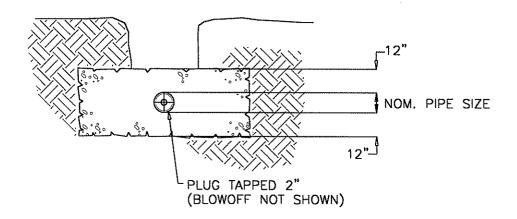

SECTION

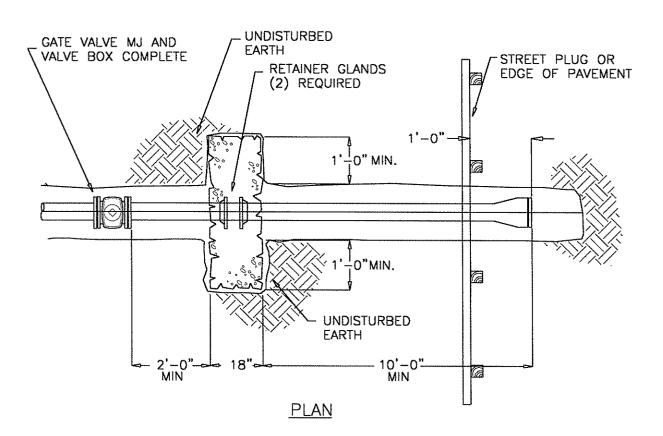

KEY COLLAR BLOCK INTO TRENCH SIDES AND BOTTOM A MINIMUM OF 1'-0"

T. KOLLN CHECKED BY: DATE:		CITY OF ST. HIELENS 265 THE STRAND, ST. HELENS, OR 97051 PH (503)397-6272 FAX (503)397-4016	REVISION:
SCALE:	TITLE:	COLLAR THRUST BLOCK	drawing no: 425


(HORIZONTAL)
BEARING AREA OF THRUST BLOCKS IN SQ. FT.

VOLUME	OF TH	HRUST	BLOCK
IN CU.	YDS.	(VERT	TCAL)


FITTING SIZE	TEE	90° BEND	45° Bend	55 1/5.	11 1/4° BEND
4	1.3	1.9	1.3		
6	2.8	4.0	2.1	1.3	
8	5.1	7.1	3.9	2.0	1.3
12	11.3	16.0	8.8	4.5	2.3

FITTING	BEND ANGLE			
SIZE	45 °	22.5*	11.25°	
4	1.1	0.4	0.2	
6	2.7	1.0	0.4	
8	4.0	1.5	0.6	
12	8.5	3.2	1.3	


VALUES BASED ON 150 PSI WATER PRESSURE AND 1500 PSF SOIL BEARING CAPACITY.

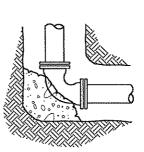




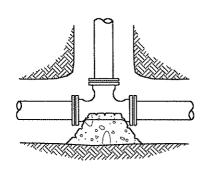

TEE

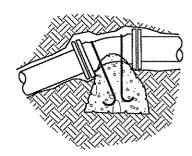

VERTICAL BEND

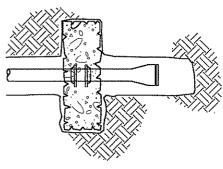

STRADDLE BLOCK

FITTING SIZE	ROD SIZE	EMBEDMENT
4"-12"	#6	30"
14"-16"	#8	36"

- 1) CONCRETE BLOCKING TO BE POURED AGAINST UNDISTURBED EARTH
- 2) ALL CONCRETE TO BE CLASS 3000
- 3) INSTALL 12 MIL TOTAL THICKNESS POLYETHENE SHEET AROUND FITTING. SECURE SHEET ENDS TO PREVENT INFILTRATION OF DIRT BETWEEN SHEET AND PIPE FITTING PRIOR TO POURING THRUST BLOCKING
- 4) PROTECT MECHANICAL JOINT FOLLOWERS AND BOLTS FROM CONCRETE WITH TEMPOARY FORMS AND POLYETHENE SHEETING SEE NOTE No. 3

DRAWN BY: T. KOLLN CHECKED BY: DATE:		CITY OF ST. HELENS 265 THE STRAND, ST. HELENS, OR 97051 PH (503)397-6272 FAX (503)397-4016	REVISION:
SCALE:	TITLE:	THRUST BLOCKING DETAILS	DRAWING NO: 430